

HOMELAND TOWERS SITE ID: NY161 -TALLMAN

VILLAGE OF MONTEBELLO 350 HAVERSTRAW RD. MONTEBELLO, NY 10901

PROJECT DESCRIPTION


INSTALLATION OF A 110 FT. MONOPINE WITHIN A 50'x50' FENCED—IN COMPOUND AT GRADE
 NSTALLATION OF A SHORT PAVED ACCESS ROAD AND GRAVEL PARKING AREA OFF THE EXISTING PARKING LOT IN THE REAR OF THE PARCEL
 INSTALLATION OF VERIZON OUTDOOR CABINETS AND A STANDBY

 INSTALLATION OF VERIZON OUTDOOR CABINETS AND A STANDBY GENERATOR ON AN EQUIPMENT PAD WITHIN FENCED COMPOUND
 INSTALLATION OF VERIZON ANTENNAS/APPERTUNANCES ON T—ARM MOUNTS AT 107 FT. A.G.L.

ELECTRICAL/TELEPHONE SERVICES ROUTED UNDERGROUND FROM NEAREST UTILITY DEMARCATION POINTS AT STREET





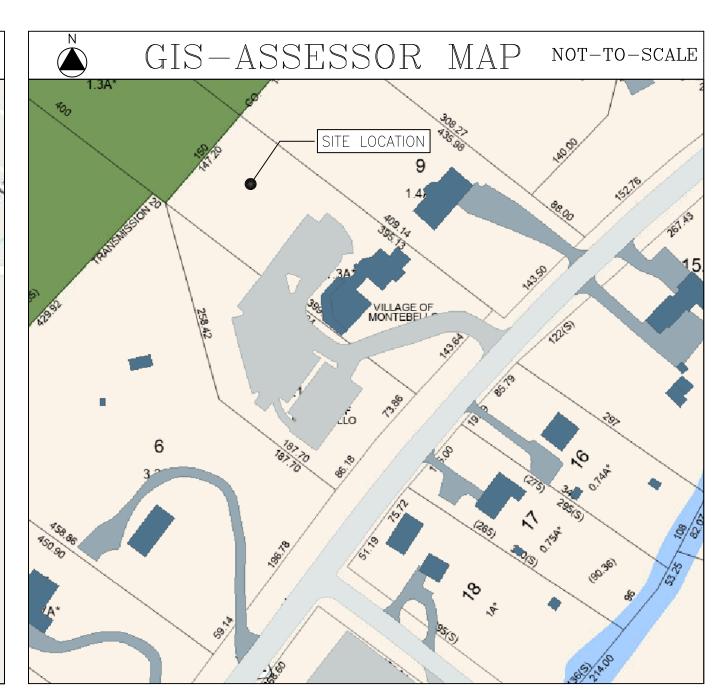

PR	OJECT SUMMARY
SITE ID:	NY161 TALLMAN
SITE ADDRESS:	350 HAVERSTRAW RD. MONTEBELLO, NY 10901
PROPERTY OWNER:	VILLAGE OF MONTEBELLO 350 HAVERSTRAW RD. MONTEBELLO, NY 10901
PARCEL ID:	48.10-1-8 (FACILITY) & 48.10-1-7 (ACCESS)
ZONING:	OSR - OPEN SPACE - RECREATION
TOWER COORDINATES:	41° 08' 06.90" N 74° 07' 52.58" W
GROUND ELEVATION:	374.6 FT. AMSL
APPLICANT:	HOMELAND TOWERS 9 HARMONY ST.; 2ND FL. DANBURY, CT 06810

	DRAWING SCHEDULE						
SHEET NO.	SHEET DESCRIPTION						
T-1	TITLE SHEET						
C-1	OVERALL SITE LAYOUT						
C-2	SITE PLAN						
C-3	LANDSCAPING/ TREE REMOVAL PLAN						
C-4	GRADING PLAN						
C-5	SITE NOTES & DETAILS						
C-6	FENCE & MISC. DETAILS						
A-1	COMPOUND PLAN, ELEVATION & ANTENNA PLAN						
VZ-1	VERIZON EQUIPMENT PLAN & DETAILS						
VZ-2	VERIZON ANTENNA PLAN & EQUIP. SPECS						





VYORK SMSA LIMITED PARTNERSHI d/b/a VERIZON WIRELESS 4 CENTEROCK ROAD WEST NYACK, NY 10994



88 Foundry Pond Road Cold Spring, NY 10516 dweinpahl@onaireng.com 201-456-4624

UNAUTHORIZED ALTERATION OR ADDITION TO A DOCUMENT PREPARED BY A LICENSED ENGINEER IS A VIOLATION OF ARTICLE 145, SECTION 7209-2 OF THE NEW STATE EDUCATION LAW.

LICENSURE



DAVID WEINPAHL, P.E. NY LIC NO. 078901

0	04.09.25	REVIEW SET
1	04.17.25	REVISED PER ATTORNEY COMMENTS
2	05.05.25	REVISED TO INCLUDE VERIZON
3	07.02.25	REVISED TOWER HEIGHT
4	10.10.25	REDUCED COMPOUND SIZE

HOMELAND TOWERS SITE ID:

NY161 TALLMAN

DW

VERIZON SITE NAME:

TALLMAN

PROJECT ADDRESS:


VILLAGE OF MONTEBELLO 350 HAVERSTRAW RD. MONTEBELLO, NY 10901

DRAWING TITLE:

TITLE SHEET


SHEET NUMBER:

T-2

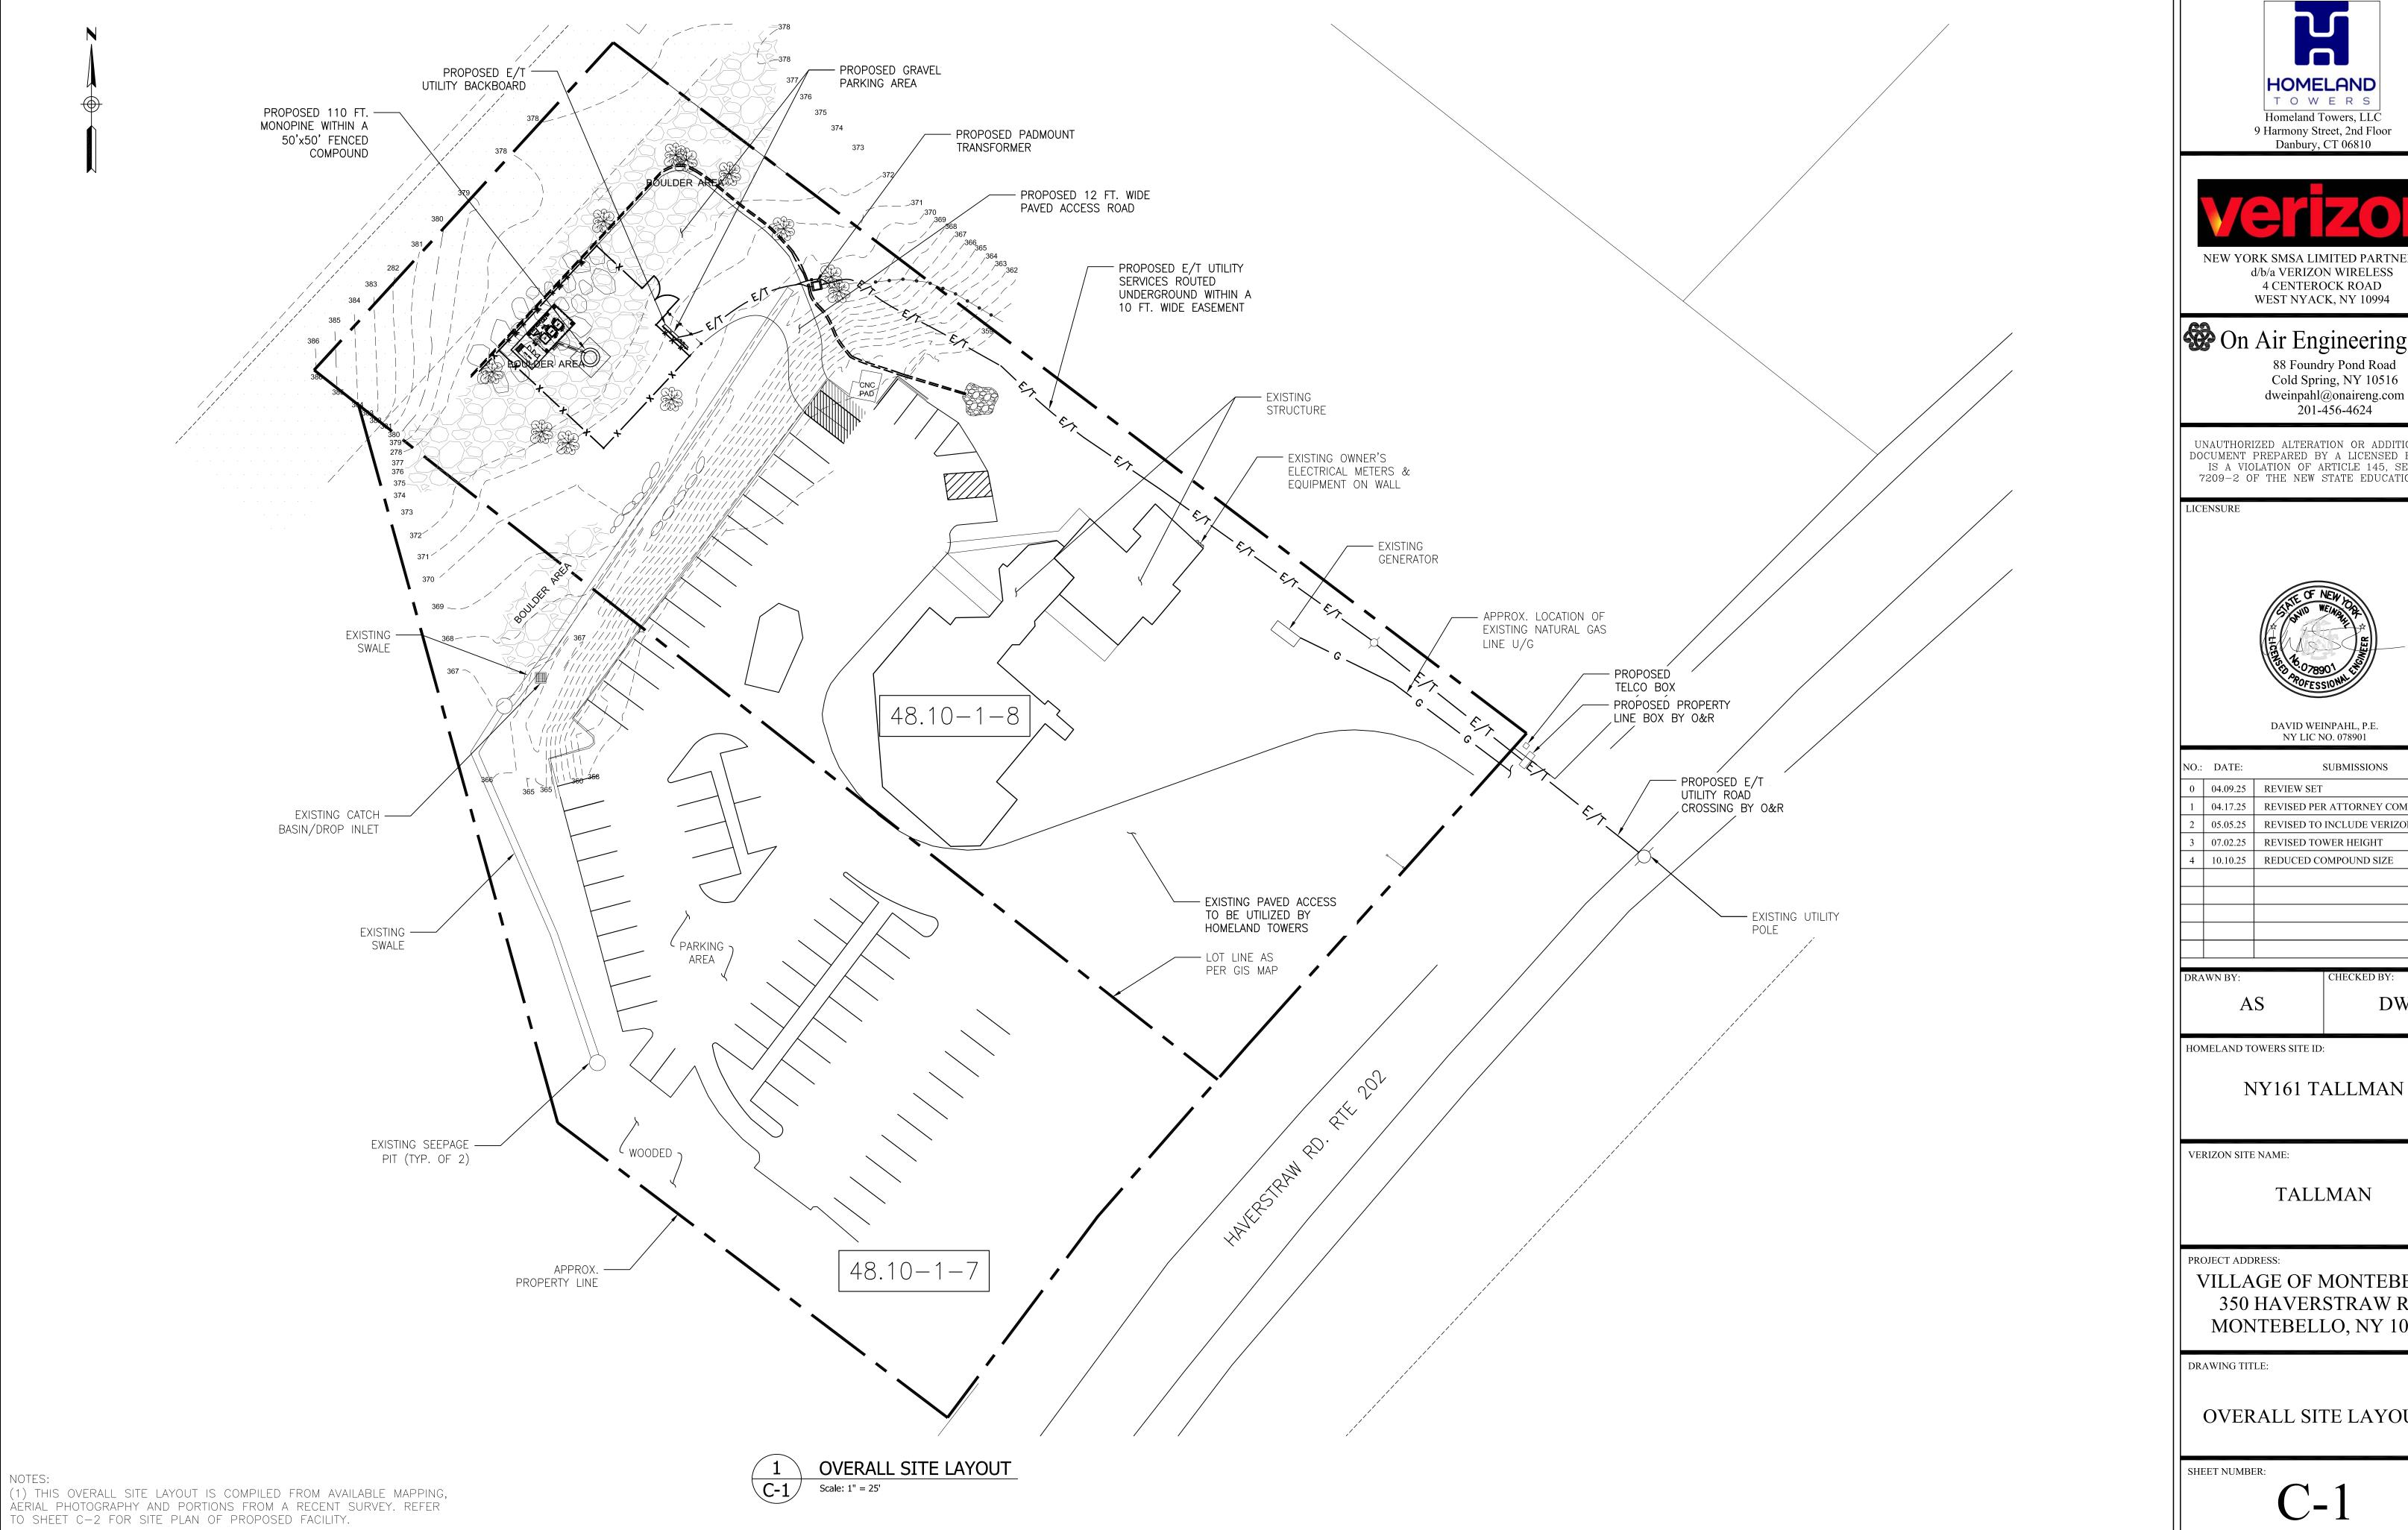





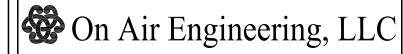

dweinpahl@onaireng.com 201-456-4624

UNAUTHORIZED ALTERATION OR ADDITION TO A DOCUMENT PREPARED BY A LICENSED ENGINEER IS A VIOLATION OF ARTICLE 145, SECTION 7209-2 OF THE NEW STATE EDUCATION LAW.




NO.:	DATE:	SUBMISSIONS			
0	04.09.25	REVIEW SET			
1	04.17.25	REVISED PER ATTORNEY COMMENTS			
2	05.05.25	REVISED TO INCLUDE VERIZON			
3	07.02.25	REVISED TOWER HEIGHT			
4	10.10.25	REDUCED COMPOUND SIZE			

DW


VILLAGE OF MONTEBELLO 350 HAVERSTRAW RD. MONTEBELLO, NY 10901

OVERALL SITE LAYOUT

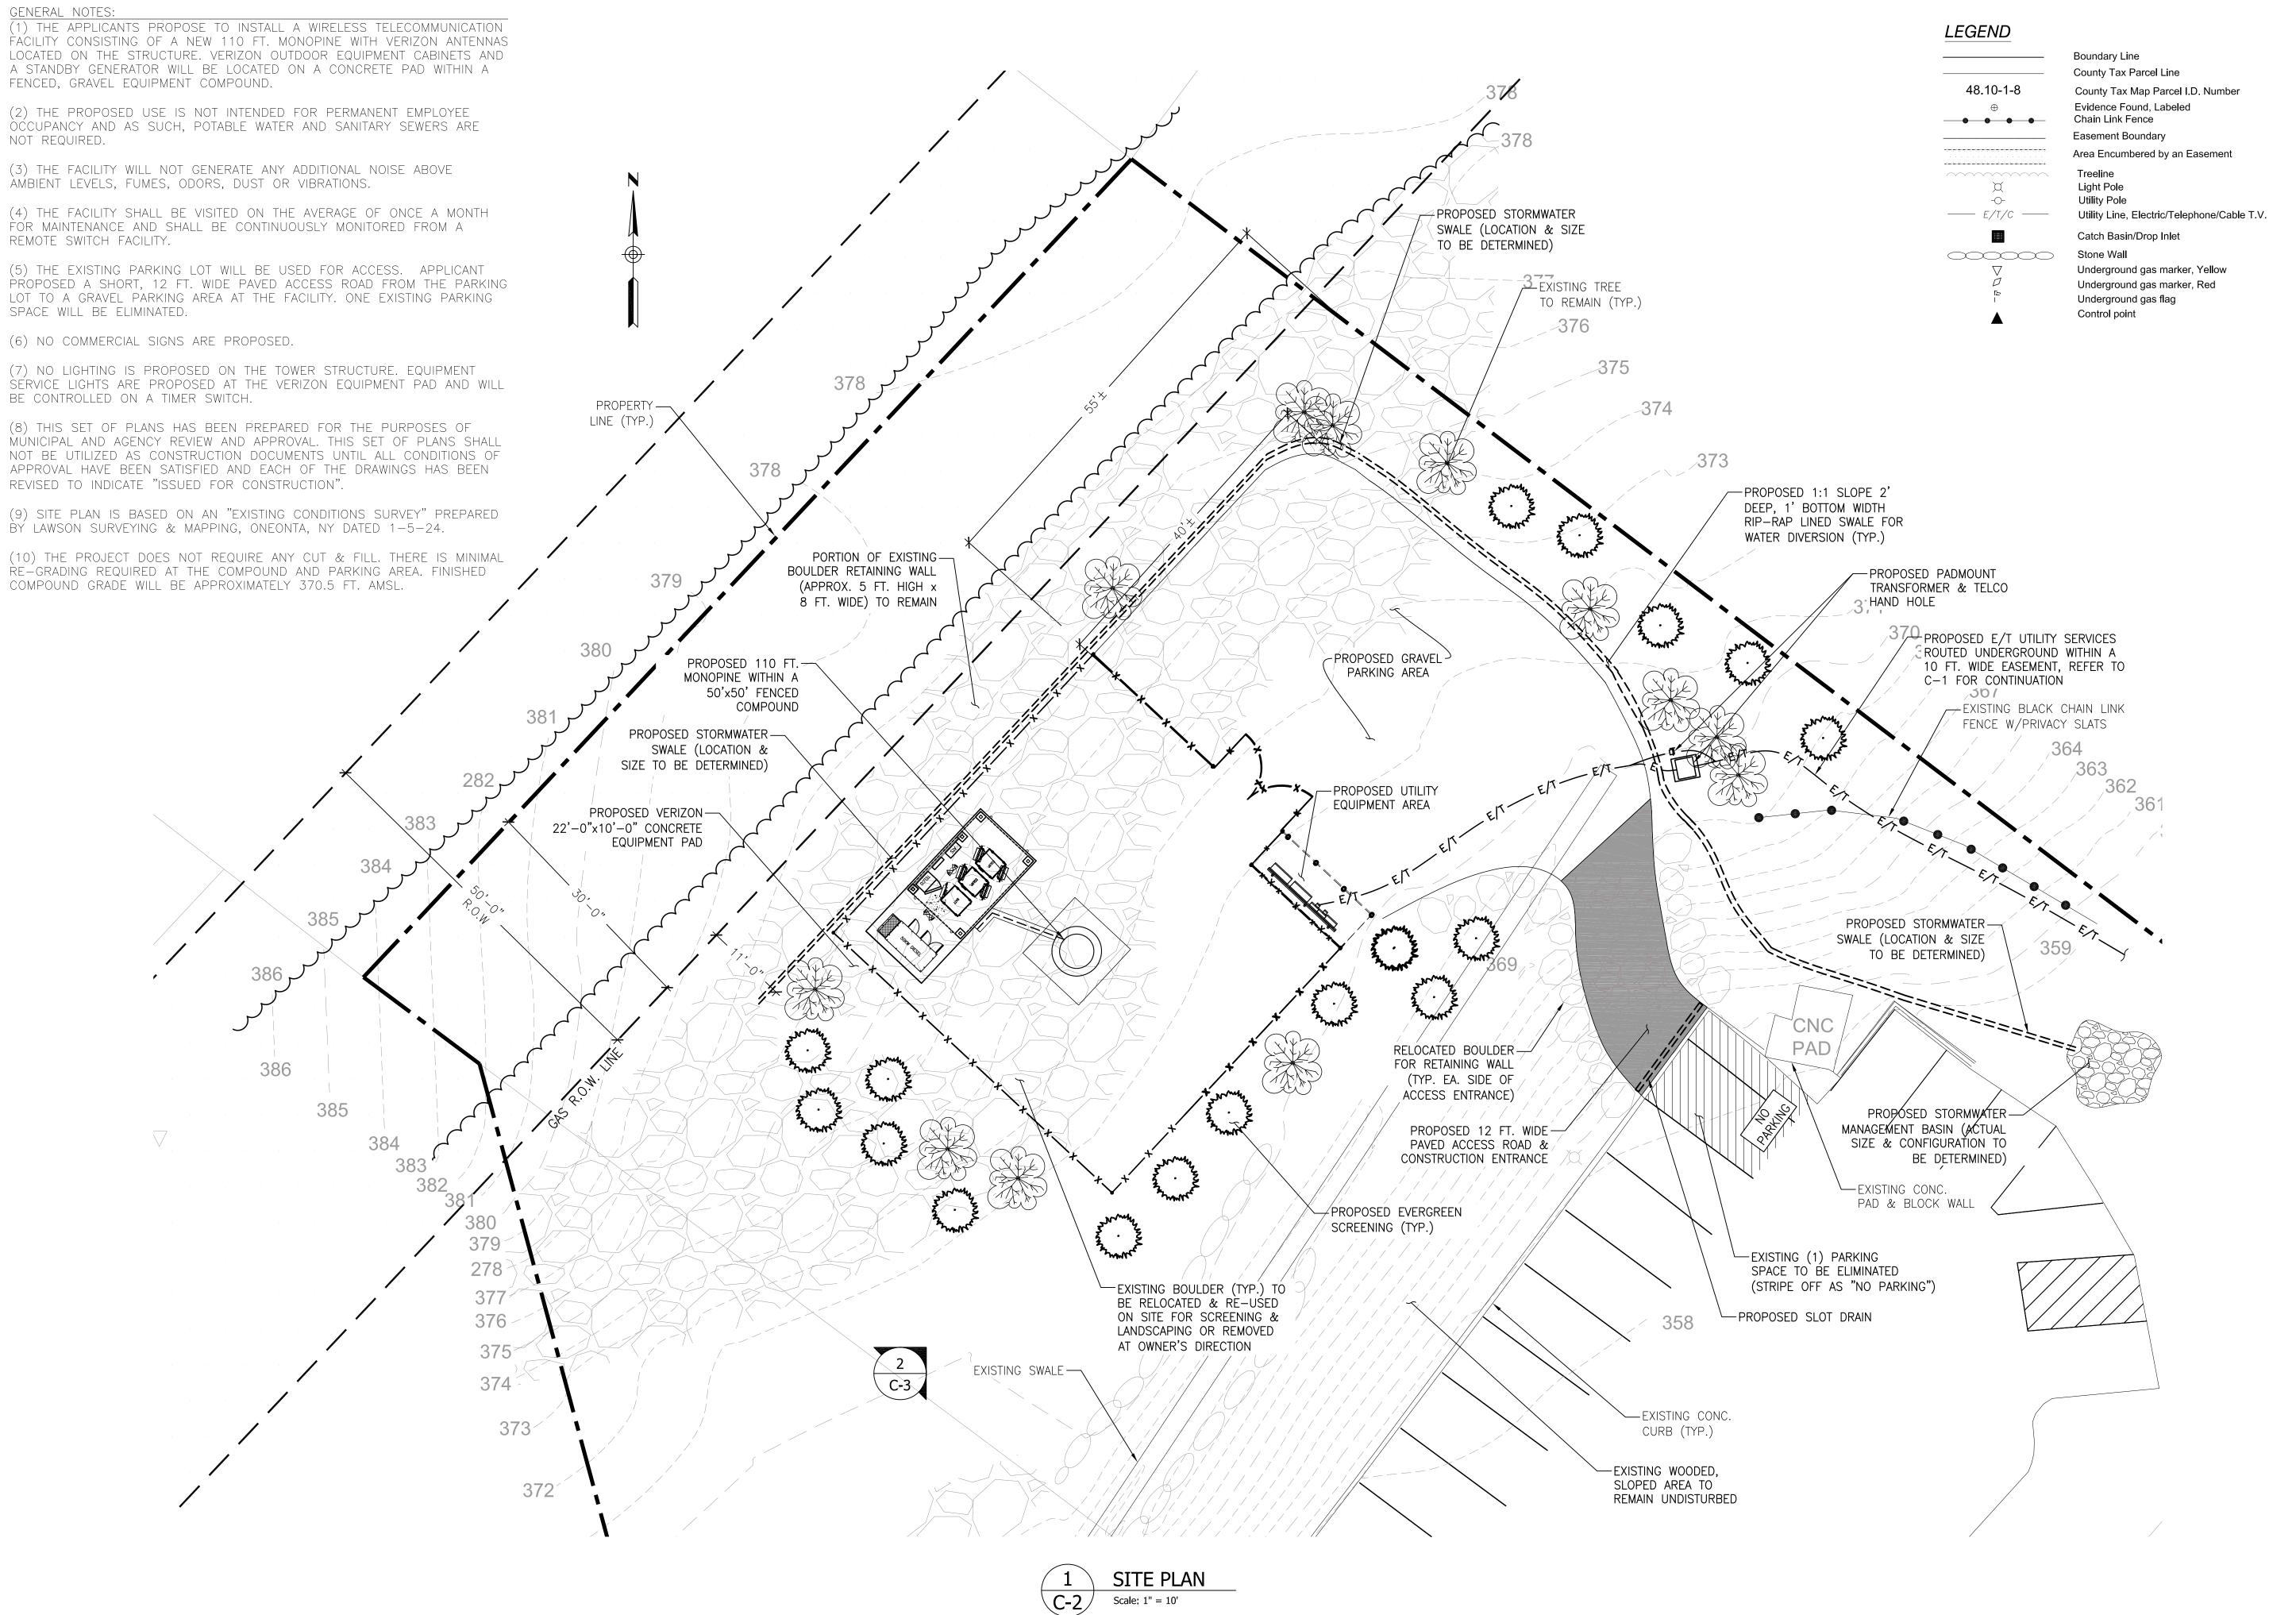





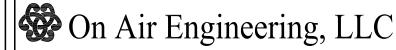

88 Foundry Pond Road Cold Spring, NY 10516 dweinpahl@onaireng.com 201-456-4624

UNAUTHORIZED ALTERATION OR ADDITION TO A DOCUMENT PREPARED BY A LICENSED ENGINEER IS A VIOLATION OF ARTICLE 145, SECTION 7209-2 OF THE NEW STATE EDUCATION LAW.

LICENSURE



DAVID WEINPAHL, P.E. NY LIC NO. 078901

NO.:	DATE:	SUBMISSIONS
0	04.09.25	REVIEW SET
1	04.17.25	REVISED PER ATTORNEY COMMENTS
2	05.05.25	REVISED TO INCLUDE VERIZON
3	07.02.25	REVISED TOWER HEIGHT
4	10.10.25	REDUCED COMPOUND SIZE

HOMELAND TOWERS SITE ID:

NY161 TALLMAN

DW

VERIZON SITE NAME:

TALLMAN

PROJECT ADDRESS:


VILLAGE OF MONTEBELLO 350 HAVERSTRAW RD. MONTEBELLO, NY 10901

DRAWING TITLE:

SITE PLAN


SHEET NUMBER:

C-2

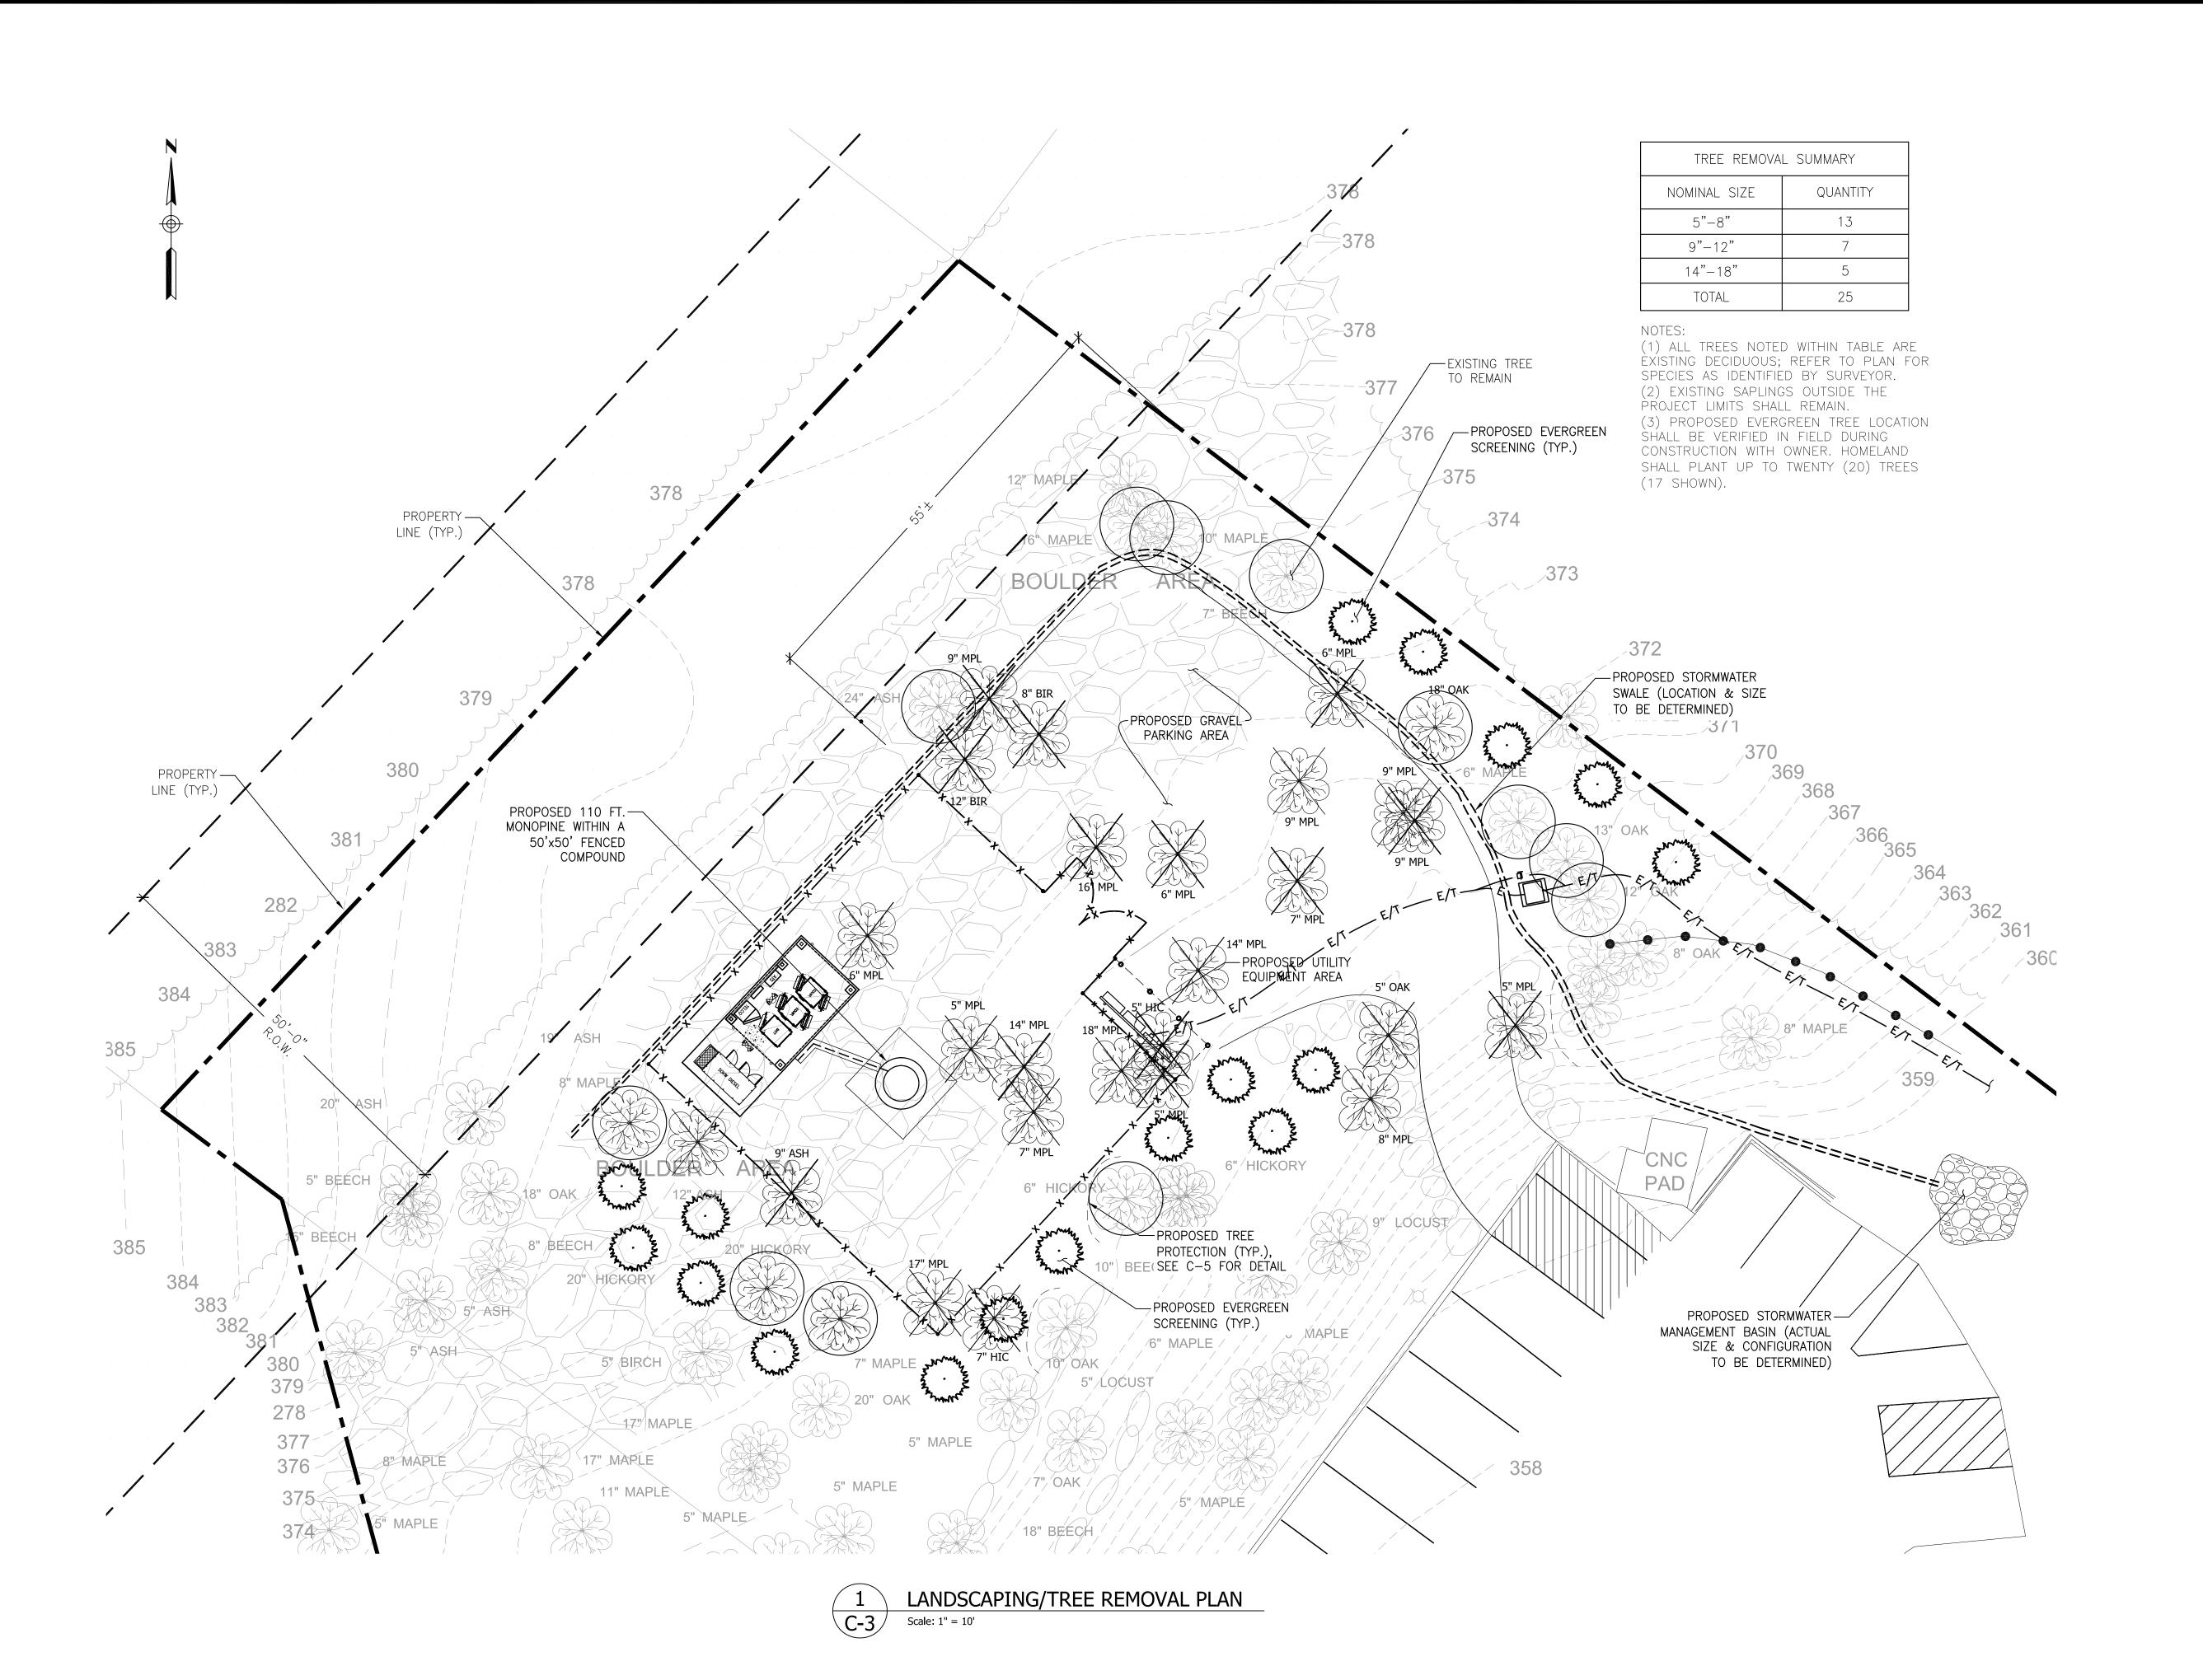





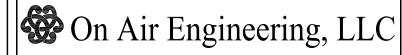

88 Foundry Pond Road Cold Spring, NY 10516 dweinpahl@onaireng.com 201-456-4624

UNAUTHORIZED ALTERATION OR ADDITION TO A DOCUMENT PREPARED BY A LICENSED ENGINEER IS A VIOLATION OF ARTICLE 145, SECTION 7209-2 OF THE NEW STATE EDUCATION LAW.

LICENSURE



DAVID WEINPAHL, P.E. NY LIC NO. 078901

NO.: DATE:		SUBMISSIONS			
0	04.09.25	REVIEW SET			
1	04.17.25	REVISED PER ATTORNEY COMMENTS			
2	05.05.25	REVISED TO INCLUDE VERIZON			
3	07.02.25	REVISED TOWER HEIGHT			
4	10.10.25	REDUCED COMPOUND SIZE			

DRAWN BY:

AS

CHECKED BY:

DW

HOMELAND TOWERS SITE ID:

VERIZON SITE NAME:

TALLMAN

NY161 TALLMAN

PROJECT ADDRESS:


VILLAGE OF MONTEBELLO 350 HAVERSTRAW RD. MONTEBELLO, NY 10901

DRAWING TITLE:

LANDSCAPING/ TREE REMOVAL PLAN


SHEET NUMBER:

C-3

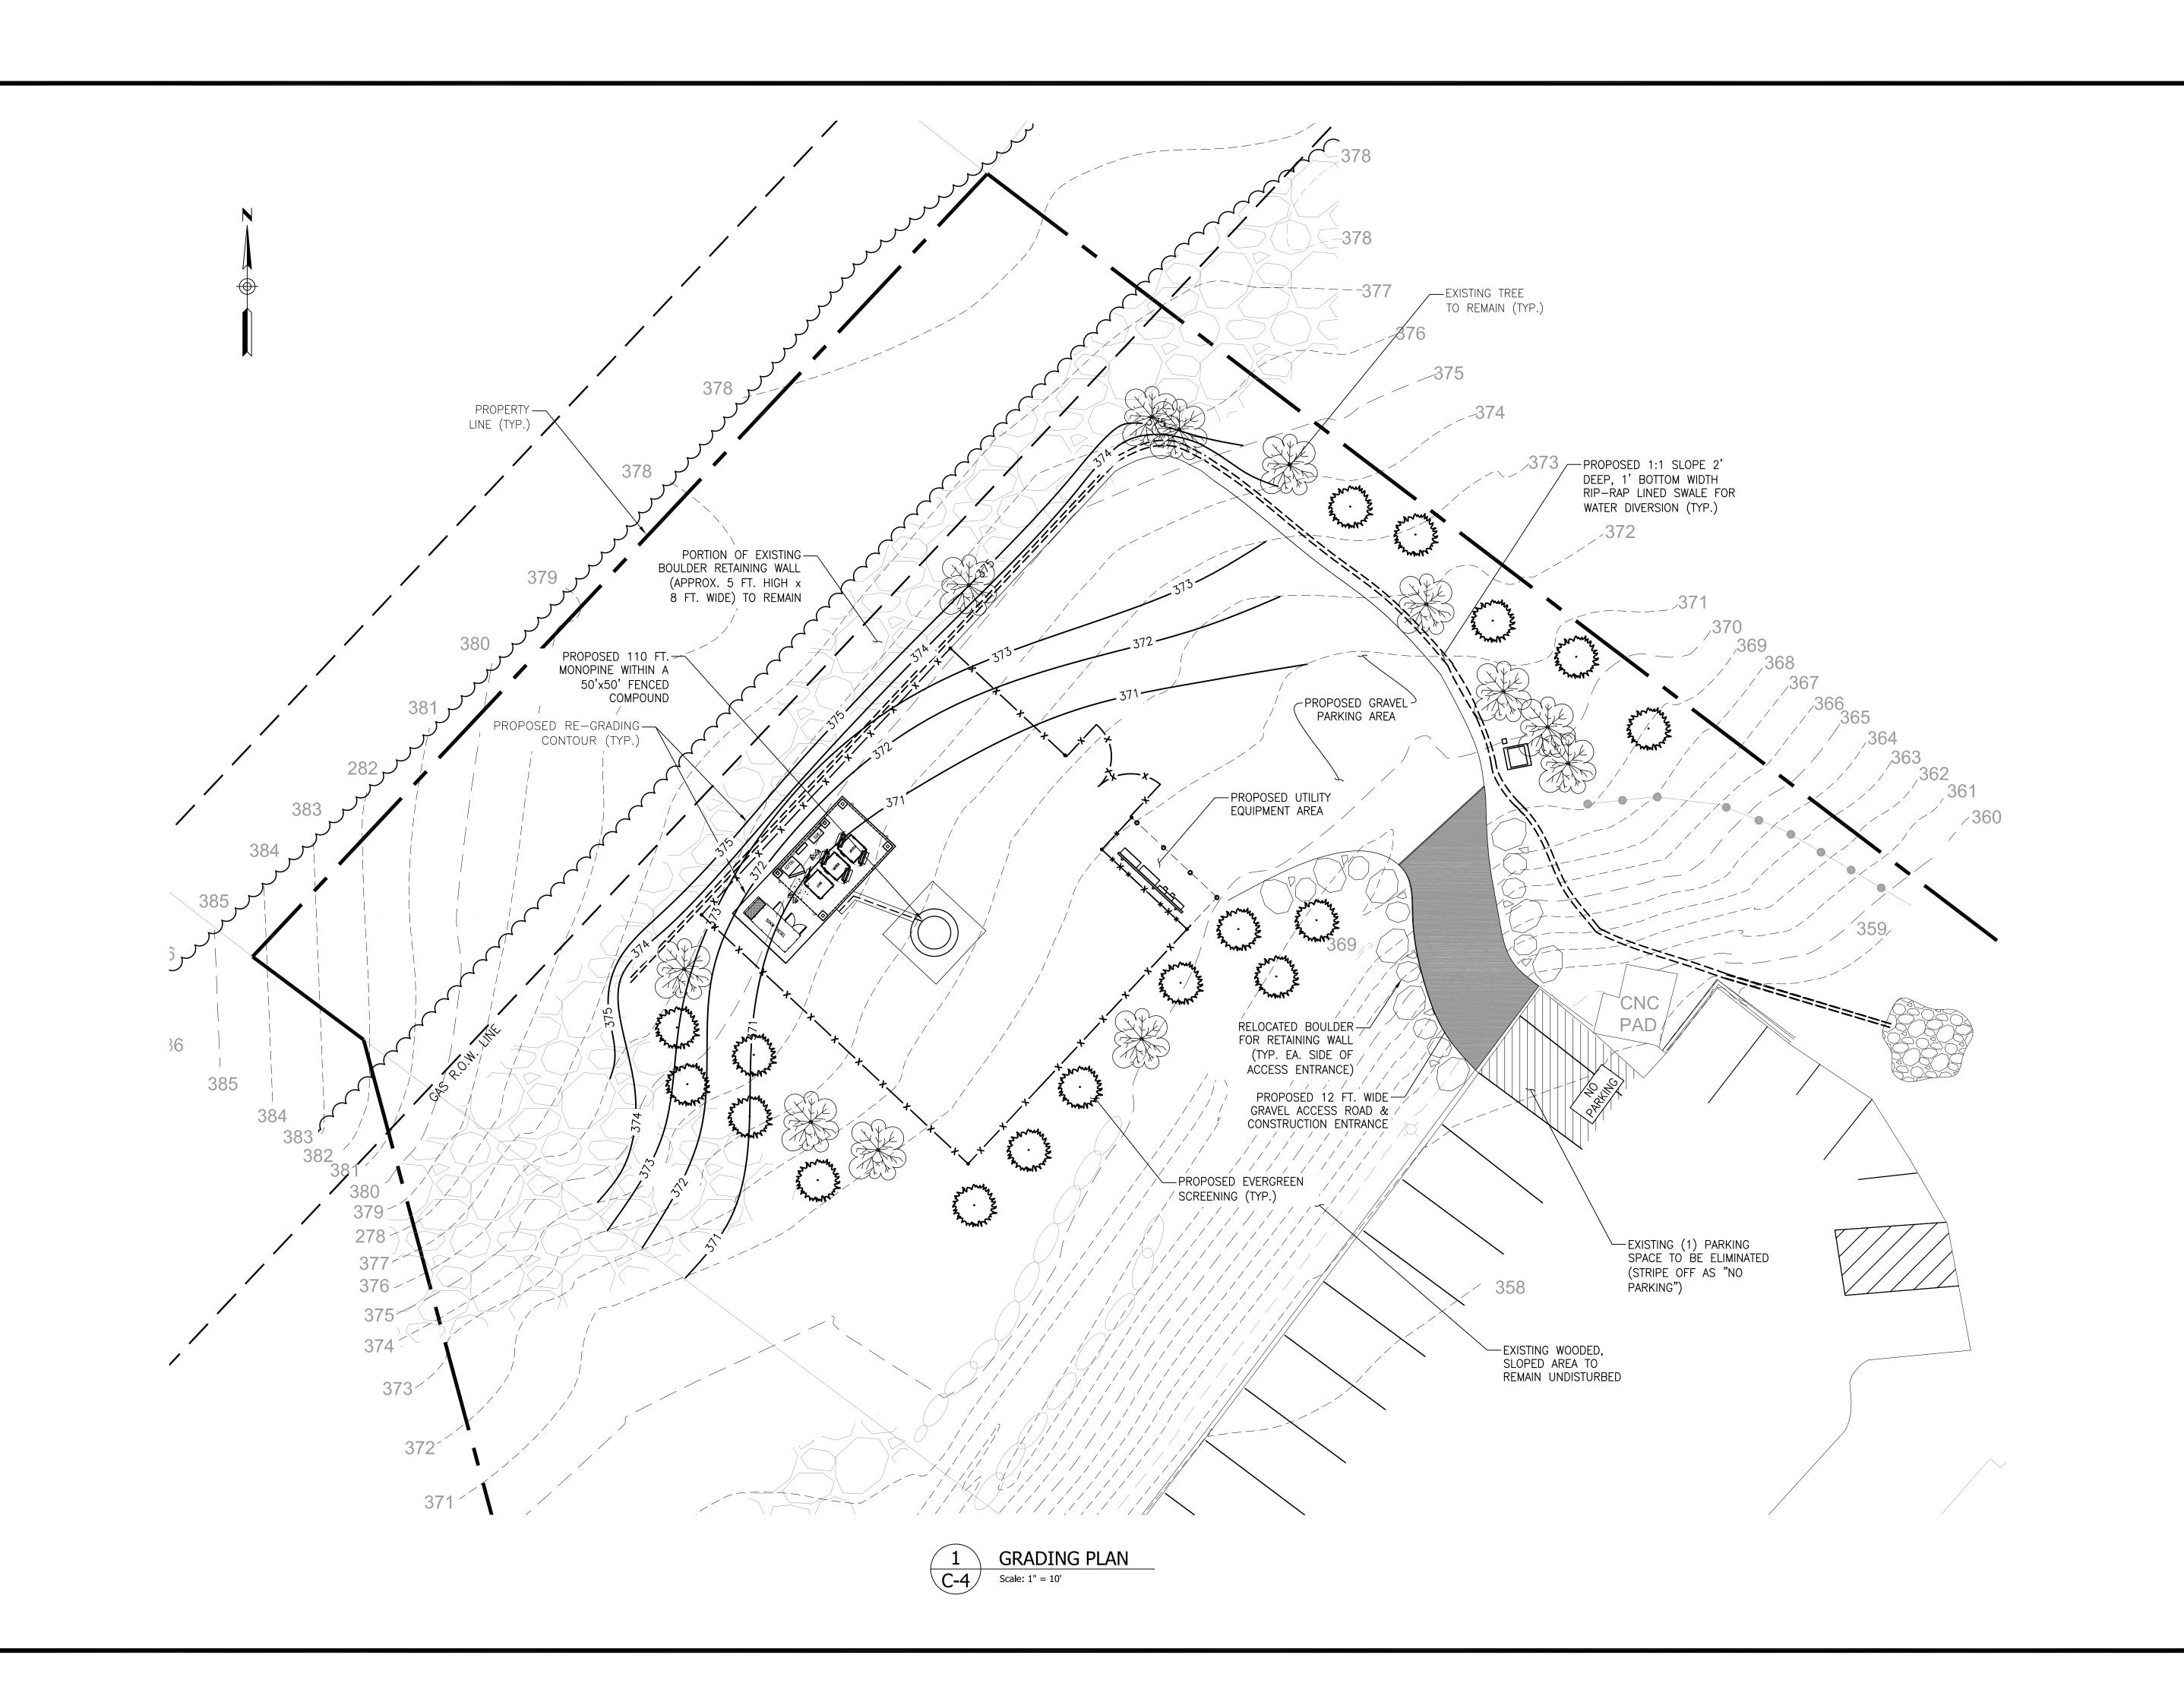





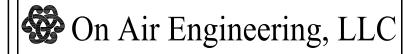

88 Foundry Pond Road Cold Spring, NY 10516 dweinpahl@onaireng.com 201-456-4624

UNAUTHORIZED ALTERATION OR ADDITION TO A DOCUMENT PREPARED BY A LICENSED ENGINEER IS A VIOLATION OF ARTICLE 145, SECTION 7209-2 OF THE NEW STATE EDUCATION LAW.

LICENSURE



DAVID WEINPAHL, P.E. NY LIC NO. 078901

NO.:	DATE:	SUBMISSIONS
0	04.09.25	REVIEW SET
1	04.17.25	REVISED PER ATTORNEY COMMENTS
2	05.05.25	REVISED TO INCLUDE VERIZON
3	07.02.25	REVISED TOWER HEIGHT
4	10.10.25	REDUCED COMPOUND SIZE

AS DW

CHECKED BY:

NY161 TALLMAN

HOMELAND TOWERS SITE ID:

VERIZON SITE NAME:

TALLMAN

PROJECT ADDRESS:

VILLAGE OF MONTEBELLO 350 HAVERSTRAW RD. MONTEBELLO, NY 10901

DRAWING TITLE:

GRADING PLAN

SHEET NUMBER:

C-4

SITE NOTES:

OF LEGALLY.

1. ALL SITE WORK SHALL BE AS INDICATED ON THE DRAWINGS.

REFUSE SHALL BE REMOVED FROM THE SITE AND DISPOSED

- 2. RUBBISH, STUMPS, DEBRIS, STICKS, STONES AND OTHER
- 3. THE SITE SHALL BE GRADED TO CAUSE SURFACE WATER TO FLOW AWAY FROM THE BTS EQUIPMENT AND TOWER AREAS.
- 4. NO FILL OR EMBANKMENT MATERIAL SHALL BE PLACED ON FROZEN GROUND, FROZEN MATERIALS, SNOW OR ICE SHALL NOT BE PLACED IN ANY FILL OR EMBANKMENT.
- 5. THE SUB GRADE SHALL BE COMPACTED AND BROUGHT TO A SMOOTH UNIFORM GRADE PRIOR TO FINISHED SURFACE APPLICATION.
- 6. ALL EXISTING ACTIVE SEWER, WATER, GAS, ELECTIC, AND OTHER UTILITIES WHERE ENCOUNTERED IN THE WORK, SHALL BE PROTECTED AT ALL TIMES, AND WHERE REQUIRED FOR THE PROPER EXECUTION OF THE WORK, SHALL BE RELOCATED AS DIRECTED BY ENGINEERS. EXTREME CAUTION SHOULD BE USED BY THE CONTRACTOR WHEN EXCAVATING OR PIER DRILLING AROUND OR NEAR UTILITIES.
- 7. ALL EXISTING INACTIVE SEWER, WATER, GAS, ELECTRIC, AND OTHER UTILITIES. WHICH INTERFERE WITH THE EXECUTION OF THE WORK, SHALL BE REMOVED AND/OR CAPPED, PLUGGED OR OTHERWISE DISCONTINUED AT POINTS WHICH WILL NOT INTERFERE WITH THE EXECUTION OF THE WORK, SUBJECT TO THE APPROVAL OF ENGINEERING.
- 8. THE AREAS OF THE OWNERS PROPERTY DISTURBED BY THE WORK SHALL BE GRADED TO A UNIFORM SLOPE, FERTILIZED, SEEDED, AND COVERED WITH MULCH.
- 9. CONTRACTOR SHALL MINIMIZE DISTURBANCE TO EXISTING SITE DURING CONSTRUCTION. EROSION CONTROL MEASURES, IF REQUIRED DURING CONSTRUCTION, SHALL BE IN CONFORMANCE WITH THE NEW YORK STATE STANDARDS AND SPECIFICATIONS FOR SEDIMENT AND EROSION CONTROL.
- 10. ALL RESTORATION ISSUES SHALL BE COMPLETED WITHIN 72 HOURS OF THE COMPLETION OF THE WORK ACTIVITY OR WITHIN A REASONABLE AMOUNT OF TIME AS DIRECTED BY THE CONSTRUCTION MANAGER/ ENGINEER.
- 11. CARE SHALL BE TAKEN TO RETAIN NATURAL GROWTH AND PREVENT DAMAGE TO TREES, WITHIN AND OUTSIDE THE LIMITS OF CONSTRUCTION AND SPECIFIED WORK AREAS, CAUSED BY EQUIPMENT AND MATERIALS. ANY DAMAGE TO THIS NATURAL GROWTH SHALL BE RESTORED AT THE EXPENSE OF THE CONTRACTOR.
- 12. ALL AREAS DISTURBED BY THE CONTRACTOR WITHOUT AUTHORIZATION SHALL BE RESTORED BY THE CONTRACTOR.
- 13. IN THE EVENT THE CONTRACTOR DAMAGES AN EXISTING UTILITY SERIVCE CAUSING AN INTERUPPTION IN SAID SERVICE. HE SHALL IMMEDIATELY COMMENCE WORK TO RESTORE SERVICE AND MAY NOT CONTINUE HIS WORK OPERATION UNTIL SERIVCE IS RESTORED.

SEEDING SPECIFICATIONS:

- A. IF GROUND HAS BEEN PREVIOUSLY MULCHED, MULCH MUST BE REMOVED OR ADDITIONAL NITROGEN MUST BE ADDED.
- B. REMOVE ALL SURFACE STONES 2" OR LARGER AS WELL AS ALL DEBRIS SUCH AS WIRE, CABLE, TREE ROOTS, PIECES OF CONCRETE, CLODS, CLUMPS, OR OTHER UNSUITABLE MATERIAL.
- C. APPLY FERTILIZER AT 7.5 POUNDS PER 1.000 SQUARE FEET AND LIME AT 200 POUNDS PER 1,000 SQUARE FEET UNLESS SOIL TESTING FOR REQUIREMENTS IS PERFORMED.
- D. NO MOWING IS TO BE UNDERTAKEN UNTIL THE MAJORITY OF THE VEGETATION IS AT LEAST 6" HIGH. MOWING SHOULD CUT THE TOP 1/3 OF VEGETATION. DO NOT UNDER ANY CIRCUMSTANCES CUT VEGETATION BELOW
- E. DO NOT APPLY ANY FORM OF WEED CONTROL UNTIL GRASS HAS BEEN MOWED AT LEAST 4 TIMES.
- F. THESE SEEDING MEASURES ARE NOT TO BE USED ON SLOPES IN EXCESS OF 2:1 GRADING.
- G. PERMANENT SEEDING MEASURES ARE TO BE USED INSTEAD OF TEMPORARY SEEDING MEASURES WHERE WORK IS TO BE SUSPENDED FOR A PERIOD OF TIME LONGER THAN 1 YEAR.
- H. IF THERE IS NO EROSION, BUT SEED SURVIVAL IS LESS THAN 100 PLANTS PER SQUARE FOOT AFTER 4 WEEKS OF GROWTH, RE-SEED AS PLANTING SEASON ALLOWS.
- I. ALL DISTURBED AREAS OUTSIDE THE PAVEMENT AREA SHALL BE LOAMED AND SEEDED IN ACCORDANCE WITH THE SUGGESTED SEEDING MIXTURES TABLE.

SILT FENCE SPECIFICATIONS:

- A. SYNTHETIC FILTER FABRIC SHALL BE A PERVIOUS SHEET OF PROPYLENE, NYLON, POLYESTER, ETHYLENE, OR SIMILAR FILAMENTS AND SHALL BE CERTIFIED BY THE MANUFACTURER OR SUPPLIER AS CONFORMING TO THE FOLLOWING MINIMUM REQUIREMENTS:
- 1. FILTERING EFFICIENCY 75 PERCENT (MIN)
- 2. GRAB TENSILE STRENGTH 100 POUNDS
- 3. ELONGATION AT FAILURE 15 PERCENT
- 4. MULLEN BURST STRENGTH 250 POUNDS PER SQUARE INCH
- 5. PUNCTURE STRENGTH 50 POUNDS
- 6. APPARENT OPENING SIZE 0.60mm < X <0.90mm
- 7. FLOW RATE

SQUARE FOOT PER MINUTE

8. PERMITTIVITY 0.05 PER SECOND


0.2 GALLONS PER

- (MIN) 9. ULTRAVIOLET RADIATION STABILITY 70 PERCENT
- AFTER 500 HOURS OF EXPOSURE (MIN) B. STAKES ARE TO BE MADE OUT OF HARDWOOD WITH A MINIMUM CROSS SECTIONAL AREA OF 1.5 SQUARE
- INCHES OR STEEL POSTS WITH A MINIMUM WEIGHT OF 0.5 POUNDS PER LINEAR FOOT. C. TORN OR PUNCTURED GEOTEXTILES SHALL NOT BE USED. ON SLOPES WHERE SURFACE FLOW FOLLOWS

THE SILT FENCE LINE, PERPENDICULAR SILT FENCE

CHECKS SHALL BE INSTALLED AT 50 FOOT INTERVALS.

D. LINES OF SILT FENCE SHOULD FOLLOW CONTOUR LINES 5-10 FEET DOWN GRADIENT FROM THE SLOPE. WHERE CONTOUR LINES CAN NOT BE FOLLOWED PERPENDICULAR WINGS SHOULD BE PLACED AT 50 FOOT INTERVALS.

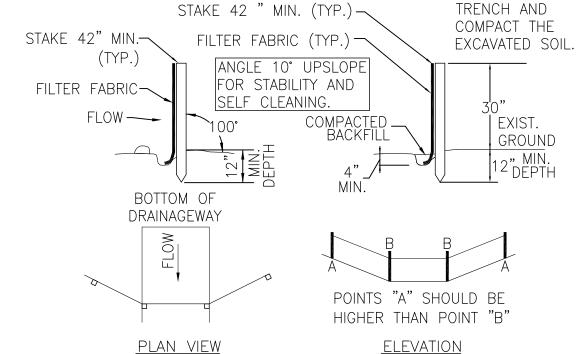


BACKFILL THE

1. MINIMUM LENGTH OF SILT FENCE IS 15 L.F.

— CHAIN LINK FENCE

- 2. MAXIMUM POST SPACING IS 10 L.F. 3. JOINTS ONLY AT SUPPORT POST WITH MINIMUM 6" OVERLAP, SECURELY SEALED.
- 4. SEDIMENTATION DEPOSITS SHALL BE REMOVED WHEN THEY REACH 1/2 THE HEIGHT OF THE SILT FENCE.
- 5. SILT FENCE SHALL NOT BE USED IN A WATER COURSE.
- 6. UPON ESTABLISHMENT OF GROUND COVER ON DISTURBED AREAS, AND WHEN DIRECTED BY THE ENGINEER, FENCE WILL BE REMOVED AND ANY SEDIMENTATION WILL BE THINLY SPREAD UPON EXISTING GROUND COVER.


SILT FENCE DETAILS AND CONSTRUCTION C-5 Scale: N.T.S.

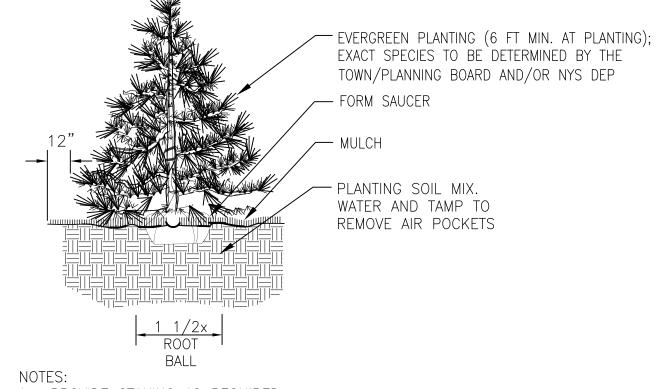

PROVIDE STAKING AS REQUIRED.

- 2. PLANT SO THAT TOP OF ROOT BALL IS EVEN WITH THE
- FINISHED GRADE 3. PAINT ALL CUTS OVER 1" DIA.
- 4. REMOVE ALL CONTAINERS AND BASKETS FROM ROOT BALL.
- 5. REMOVE BURLAP FROM TOP 1/3 OF ROOT BALL.



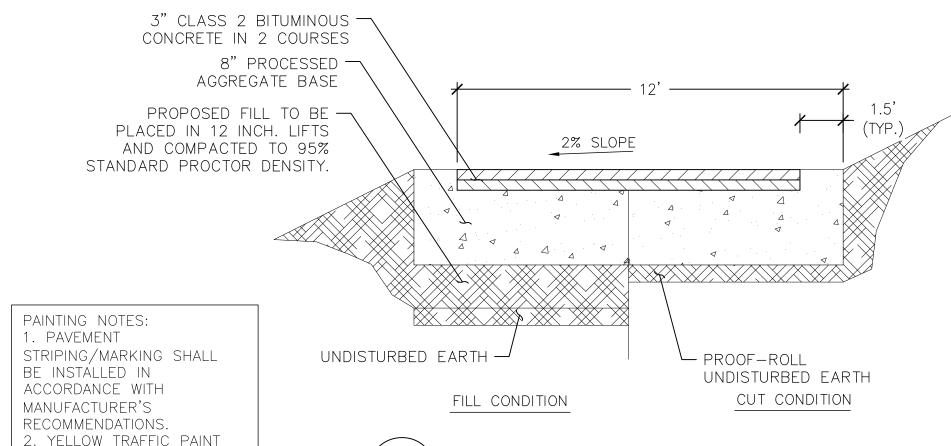

C-5 Scale: N.T.S.

- TRENCH SURFACE RESTORATION

AS REQUIRED TO MATCH



TREE PROTECTION NOTES:

1. BEFORE BEGINNING ANY SITE WORK OR CONSTRUCTION, TREE PROTECTION FENCING SHALL BE INSTALLED AROUND TREES INDICATED TO REMAIN ON THIS PLAN. FOLLOWING THE INSTALLATION OF TREE PROTECTION FENCING AND FOR THE ENTIRE CONSTRUCTION PERIOD THE FOLLOWING SHALL APPLY:

10'-0''

MAXIMUM

DRIPLINE (VARIES)

FENCE LOCATION

(LIMITS OF CRITICAL ROOT ZONE)

DIAMETER=1 FOOT PER INCH

OF TRUNK DIAMETER

•NO MATERIALS, VEHICLES OR EQUIPMENT MAY BE STORED OR STOCKPILED WITHIN THE AREAS ENCLOSED BY TREE PROTECTION FENCING •NO VEHICLES OR EQUIPMENT MAY BE DRIVEN, OPERATED OR PARKED WITHIN AREAS ENCLOSED BY TREE PROTECTION. • AREAS ENCLOSED BY TREE PROTECTION CAN NOT BE USED AS ROUTES FOR SITE TRAFFIC • FENCING SHALL BE RESECURED AS NECESSARY AND MAINTAINED TAUT. FENCING SHALL BE REPAIRED OR REPLACED WHEN DAMAGED AT THE CONTRACTOR'S EXPENSE. •IN SPECIAL CASES WHERE CONSTRUCTION OPERATIONS ABSOLUTELY REQUIRE SOME TEMPORARY ENCROACHMENT INTO TREE PROTECTION AREAS, THE CONTRACTOR SHALL PRESENT A WORK PLAN FOR TEMPORARY ENCROACHMENT FOR THE OWNER'S

2. ALL EXCAVATION OR TRENCHING WITHIN THE AREAS OF EXISTING TREE ROOTS SHALL BE PERFORMED BY HAND. •ROOTS IN TRENCH SHALL BE CUT SMOOTH AND CLEAN USING SHARP TOOLS. NO RIPPING OF TREE ROOTS BY MACHINES IS


PERMITTED. •NO JAGGED EDGES OF ROOTS SHALL BE PERMITTED. • SIDES OF EXCAVATIONS SHALL BE CLEAN AND STRAIGHT.

• IMMEDIATELY FOLLOWING TRENCHING OR EXCAVATION OPERATIONS, AREAS AT TREE ROOTS SHALL BE BACKFILLED. •ROOTS SHALL NOT BE LEFT EXPOSED OVERNIGHT. •BACKFILL SHALL BE A MIX OF 50% TOPSOIL AND 50% CLEAN SAND.

•BACKFILL SHALL BE HAND COMPACTED IN PLACE TO FILL ALL VOIDS. 3. EXTREME CARE SHALL BE TAKEN TO AVOID ANY DAMAGE TO TRUNKS, BRANCHES AND ROOTS. ANY DAMAGE CAUSED TO TREES SHALL BE IMMEDIATELY REMEDIED BY THE CONTRACTOR. • REMEDIAL WORK MAY INCLUDE PRUNING. WOUND TREATMENT, CABLING OR ADDITIONAL MEASURES AS DETERMINED BY THE OWNER OR THEIR AGENT. 4. THE CONTRACTOR SHALL REVIEW ALL PLANNED CONSTRUCTION OPERATIONS THAT MAY RESULT IN TREE DAMAGE FOR

REVIEW AND APPROVAL BY THE OWNER OR THEIR AGENT. • SPECIAL ATTENTION SHALL BE MADE TO THE PATH OF PLACING CONSTRUCTION MATERIAL ON SITE BY CRANE. • THE CONTRACTOR SHALL PRESENT A WORK PLAN AND PROPOSED TREE PROTECTION MEASURES TO MINIMIZE DAMAGE TO

TREE PROTECTION DETAIL Scale: N.T.S

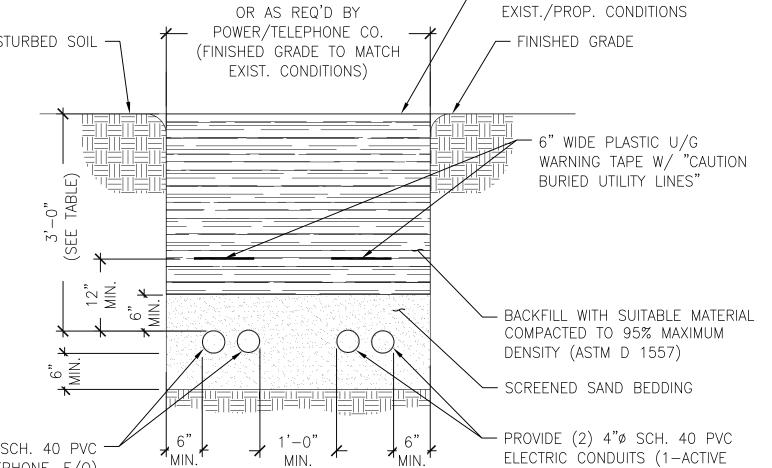

PROVIDE (2) 4"ø SCH. 40 PVC COMMUNICATION (TELEPHONE, F/O) CONDUITS WITH 200 LB MIN. TENSILE STRENGTH PULL TAPE. TELEPHONE COMPANY WILL SUPPLY AND INSTALL TELEPHONE LINES.

SHALLOW BURIED CONDUIT TABLE CONDUIT | REQ'D CONCRETE COVER (IN) DEPTH (IN) 36 Ω 30 24 4

1. THE CLEAN FILL SHALL PASS THROUGH A

CONTAIN SHARP STONES. OTHER BACKFILL

SHELLS, FROZEN MATERIAL, LOOSE DERBIES

OR STONES LARGER THAN 2" IN MAXIMUM

DIMENSION. WHERE EXISTING UTILITIES

UTILITY MARKOUT COMPANY TO LOCATE

ON PARCEL. HAND DIG ONLY WHERE

EXISTING OWNER'S AND OTHER UTILITIES

REQUIRED TO PROTECT EXISTING UTILITIES.

ARE LIKELY TO BE ENCOUNTERED.

2. CONTRACTOR SHALL RETAIN A PRIVATE

3/8" MESH SCREEN AND SHALL NOT

SHALL NOT CONTAIN ASHES, CINDERS,

* MINIMUM COVER REQUIREMENT

18*

HOMELAND TOWERS Homeland Towers, LLO 9 Harmony Street, 2nd Floor Danbury, CT 06810



NEW YORK SMSA LIMITED PARTNERSHIP d/b/a VERIZON WIRELESS 4 CENTEROCK ROAD WEST NYACK, NY 10994



88 Foundry Pond Road Cold Spring, NY 10516 dweinpahl@onaireng.com 201-456-4624

UNAUTHORIZED ALTERATION OR ADDITION TO A DOCUMENT PREPARED BY A LICENSED ENGINEER IS A VIOLATION OF ARTICLE 145, SECTION 7209-2 OF THE NEW STATE EDUCATION LAW.

LICENSURE



DAVID WEINPAHL, P.E. NY LIC NO. 078901

1		
0	04.09.25	REVIEW SET
1	04.17.25	REVISED PER ATTORNEY COMMENTS
2	05.05.25	REVISED TO INCLUDE VERIZON
3	07.02.25	REVISED TOWER HEIGHT
4	10.10.25	REDUCED COMPOUND SIZE

HOMELAND TOWERS SITE ID:

NY161 TALLMAN

VERIZON SITE NAME:

TALLMAN


PROJECT ADDRESS:

VILLAGE OF MONTEBELLO 350 HAVERSTRAW RD. MONTEBELLO, NY 10901

DRAWING TITLE:

SITE NOTES & CIVIL DETAILS

SHEET NUMBER:

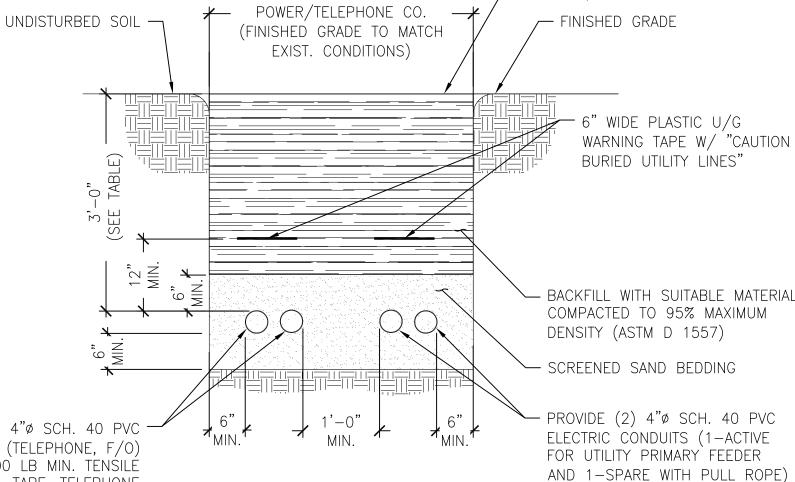

SHALL MATCH EXISTING AND


3'-8"± WIDE TRENCH

BE APPROVED BY THE

PRIOR TO APPLICATION.


OWNER'S REPRESENATIVE

PRIMARY UTILITY TRENCH **∖C-5**/ Scale: N.T.S.

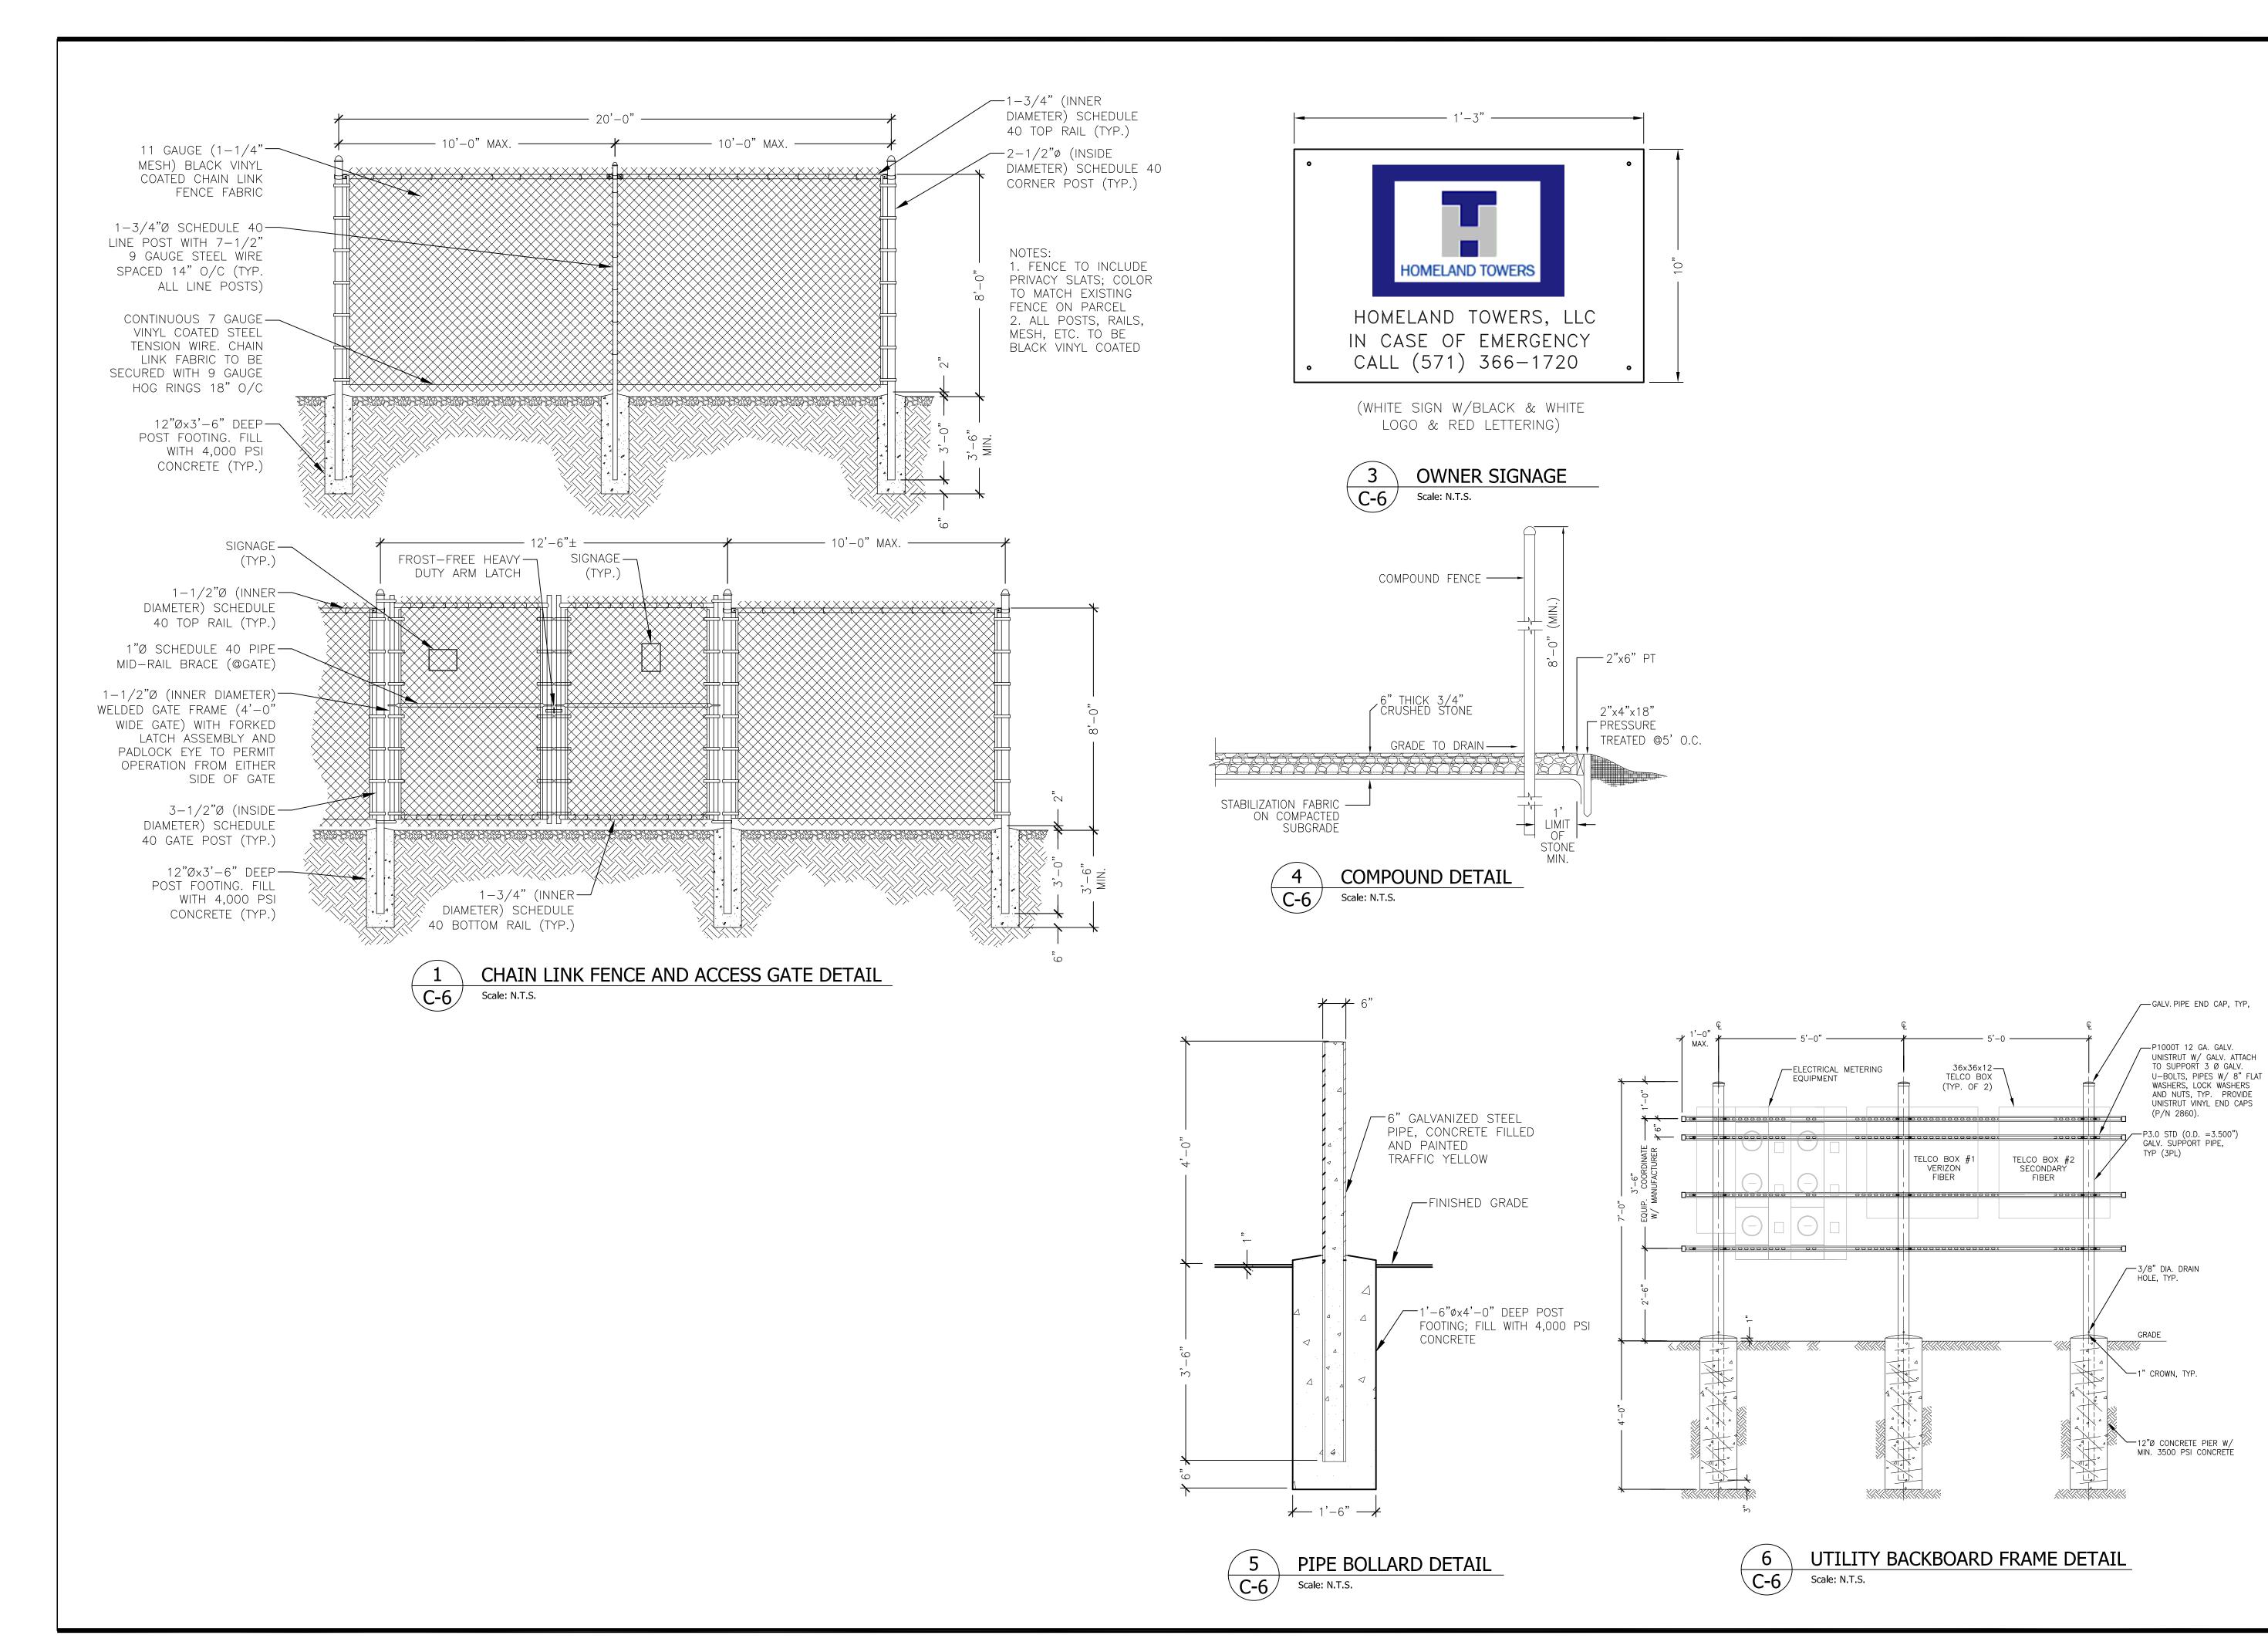






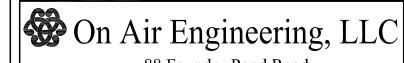

88 Foundry Pond Road Cold Spring, NY 10516 dweinpahl@onaireng.com 201-456-4624

UNAUTHORIZED ALTERATION OR ADDITION TO A DOCUMENT PREPARED BY A LICENSED ENGINEER IS A VIOLATION OF ARTICLE 145, SECTION 7209-2 OF THE NEW STATE EDUCATION LAW.

LICENSURE

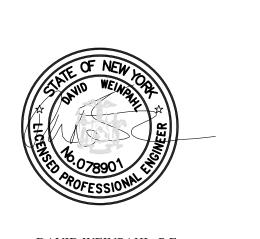

DAVID WEINPAHL, P.E.

0	04.09.25	REVIEW SET
1	04.17.25	REVISED PER ATTORNEY COMMENTS
2	05.05.25	REVISED TO INCLUDE VERIZON
3	07.02.25	REVISED TOWER HEIGHT
4	10.10.25	REDUCED COMPOUND SIZE

HOMELAND TOWERS SITE ID:

(P/N 2860).

AS

NY161 TALLMAN

DW

VERIZON SITE NAME:

TALLMAN


PROJECT ADDRESS:

VILLAGE OF MONTEBELLO 350 HAVERSTRAW RD. MONTEBELLO, NY 10901

DRAWING TITLE:


FENCE & MISC. DETAILS

SHEET NUMBER:

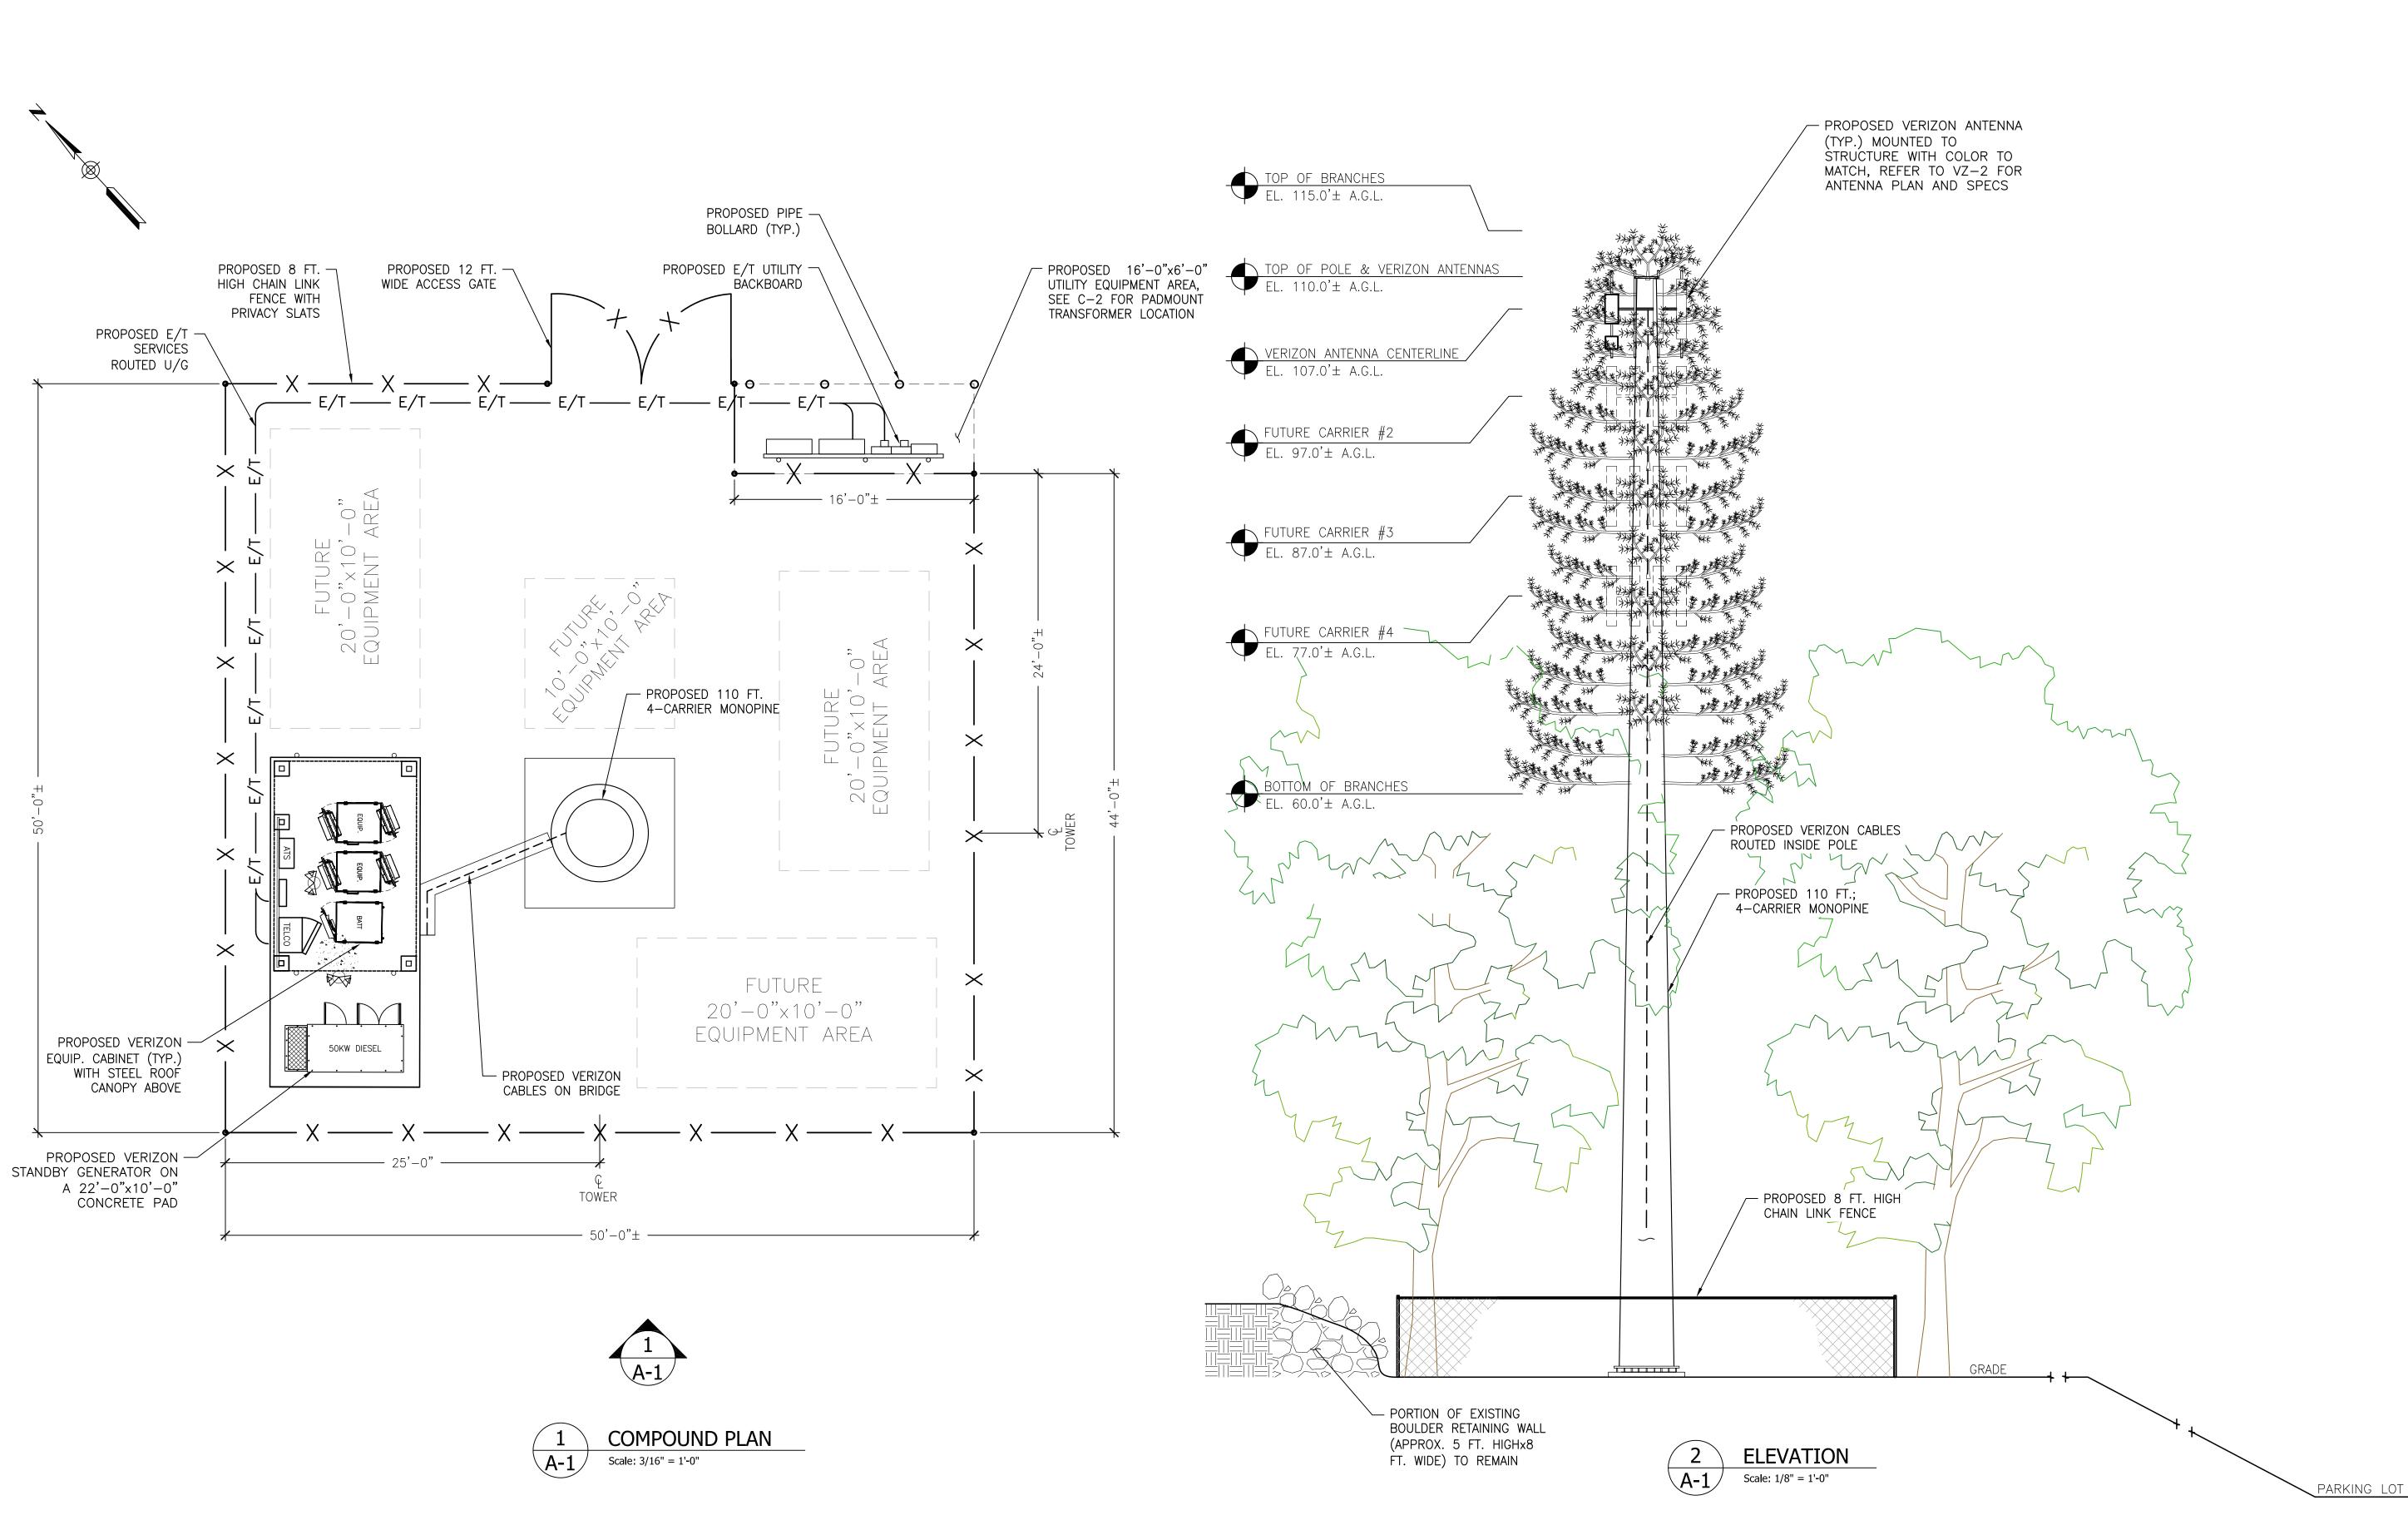





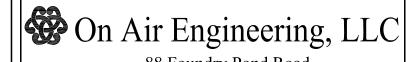

88 Foundry Pond Road Cold Spring, NY 10516 dweinpahl@onaireng.com 201-456-4624

UNAUTHORIZED ALTERATION OR ADDITION TO A DOCUMENT PREPARED BY A LICENSED ENGINEER IS A VIOLATION OF ARTICLE 145, SECTION 7209-2 OF THE NEW STATE EDUCATION LAW.

LICENSURE



DAVID WEINPAHL, P.E. NY LIC NO. 078901

0	04.09.25	REVIEW SET
1	04.17.25	REVISED PER ATTORNEY COMMENTS
2	05.05.25	REVISED TO INCLUDE VERIZON
3	07.02.25	REVISED TOWER HEIGHT
4	10.10.25	REDUCED COMPOUND SIZE

DRAWN BY:

CHECKED BY:

DW

HOMELAND TOWERS SITE ID:

NY161 TALLMAN

VERIZON SITE NAME:

TALLMAN

PROJECT ADDRESS:


VILLAGE OF MONTEBELLO 350 HAVERSTRAW RD. MONTEBELLO, NY 10901

DRAWING TITLE:


COMPOUND PLAN & ELEVATION

SHEET NUMBER:

A-1

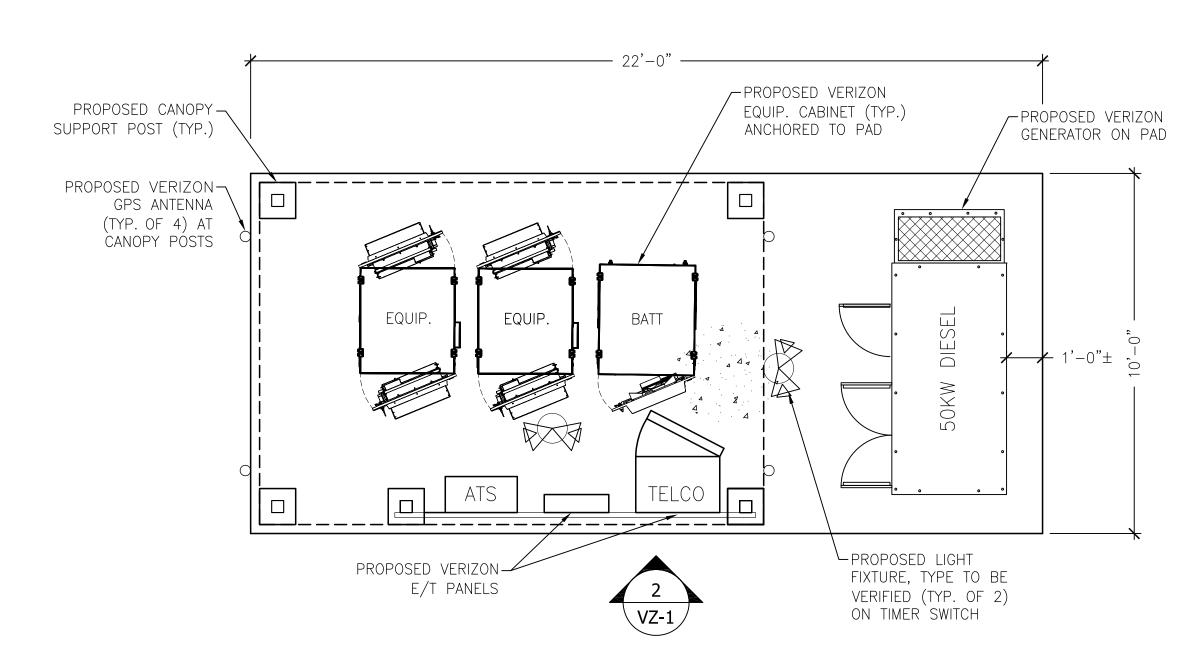



1 EQUIPMENT PLAN VZ-1 Scale: 3/8" = 1'-0"

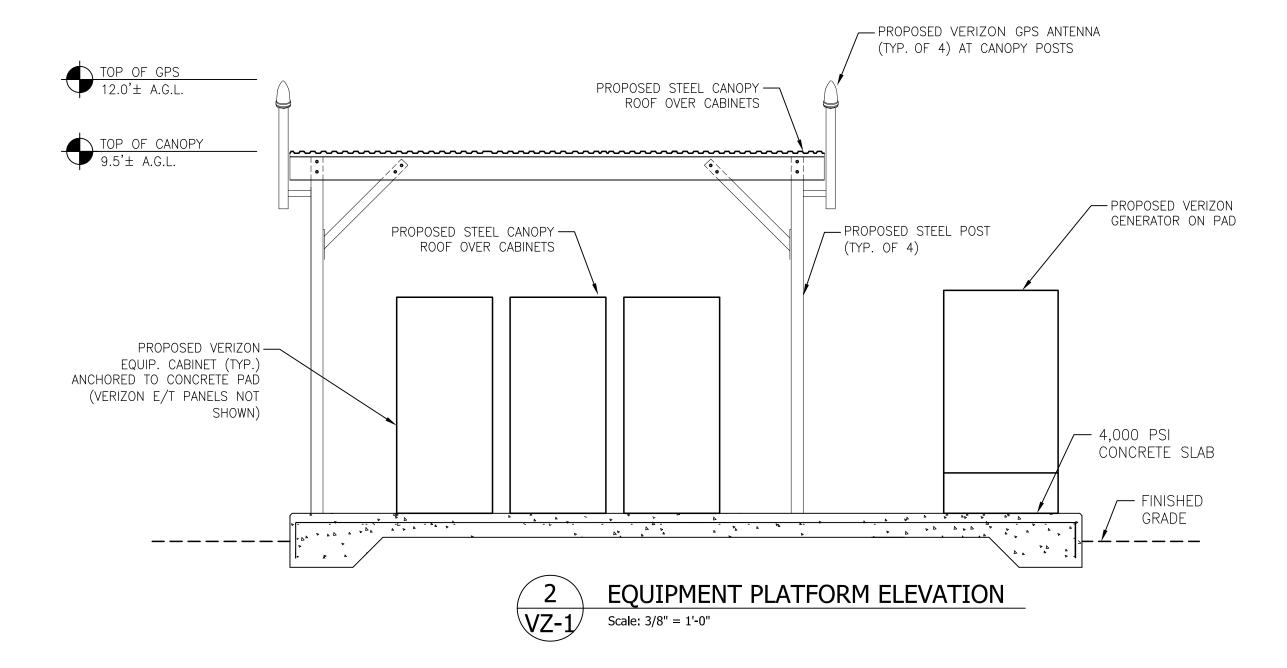

NOTES TO VERIZON EQUIPMENT DETAILS/SPECIFICATIONS:

1. EQUIPMENT IS SUBJECT TO CHANGE BASED ON AVAILABILITY AT TIME OF CONSTRUCTION.

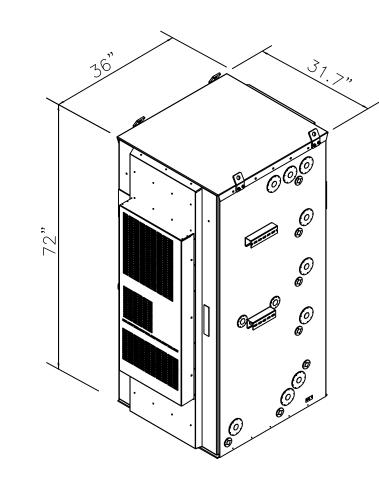

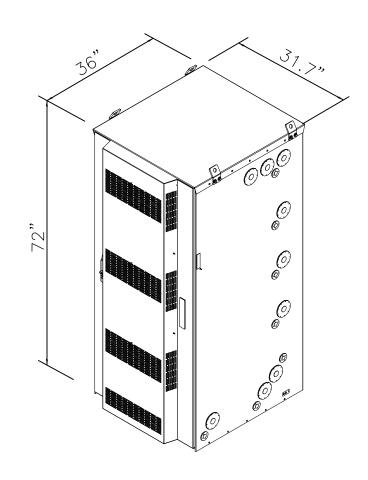

WIDTH DEFINITION WEIGHT	DELTA BATTERY CABINET				D	ELTA EQU	IPMENT CA	BINET
31.7" 36" 2,500 LBS 72" 31.7" 36" 800 LB	WIDTH	DEPTH	WEIGHT		HEIGHT	WIDTH	DEPTH	WEIGHT
	31.7"	36"	2,500 LBS]	72"	31.7"	36"	800 LBS



HEIGHT






GENERAC GENERATOR SPECIFICATIONS							
MODEL #	LENGTH	WIDTH	HEIGHT	WEIGHT			
SD050	94.8"	38.0"	74.5"	2,996 LBS			

1. DIMENSIONS INCLUDE A 132 GALLON BASE TANK AND LEVEL 2 SOUND ATTENUATED ENCLOSURE 2. IMAGE SHOWS LARGER BASE TANK THAN PROPOSED



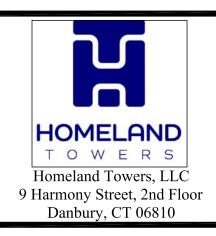



NEW YORK SMSA LIMITED PARTNERSHIP d/b/a VERIZON WIRELESS 4 CENTEROCK ROAD WEST NYACK, NY 10994



88 Foundry Pond Road Cold Spring, NY 10516 dweinpahl@onaireng.com 201-456-4624

UNAUTHORIZED ALTERATION OR ADDITION TO A DOCUMENT PREPARED BY A LICENSED ENGINEER IS A VIOLATION OF ARTICLE 145, SECTION 7209-2 OF THE NEW STATE EDUCATION LAW.

LICENSURE



DAVID WEINPAHL, P.E. NY LIC NO. 078901

Ю.:	DATE:	SUBMISSIONS
0	04.09.25	REVIEW SET
1	04.17.25	REVISED PER ATTORNEY COMMENTS
2	05.05.25	REVISED TO INCLUDE VERIZON
3	07.02.25	REVISED TOWER HEIGHT
4	10.10.25	REDUCED COMPOUND SIZE

DRAWN BY:

CHECKED BY:

DW

HOMELAND TOWERS SITE ID:

NY161 TALLMAN

VERIZON SITE NAME:

TALLMAN

PROJECT ADDRESS:


VILLAGE OF MONTEBELLO 350 HAVERSTRAW RD. MONTEBELLO, NY 10901


DRAWING TITLE:


VERIZON EQUIPMENT PLAN & DETAILS

SHEET NUMBER:


VZ-1

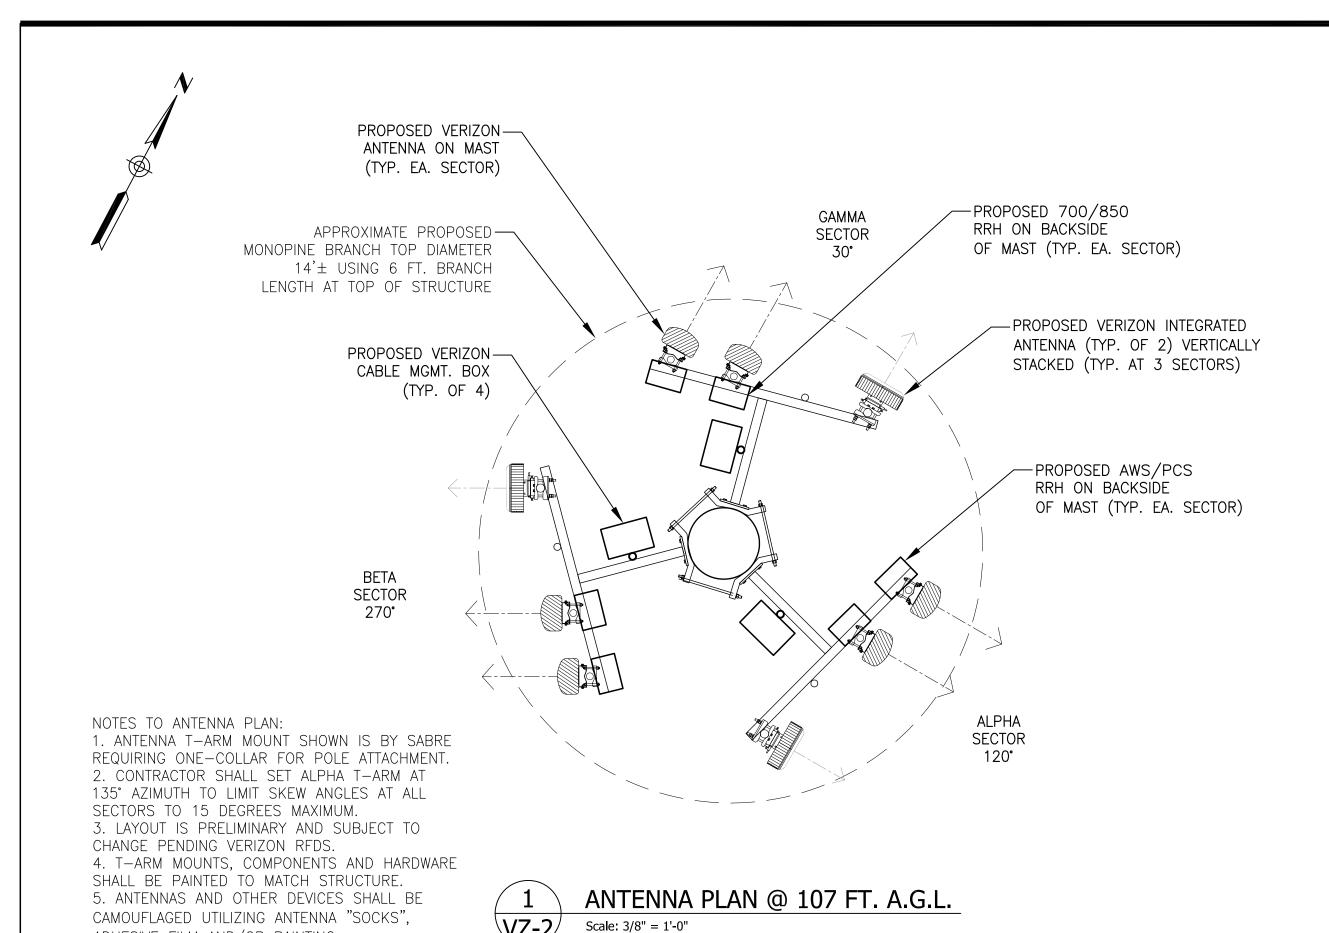

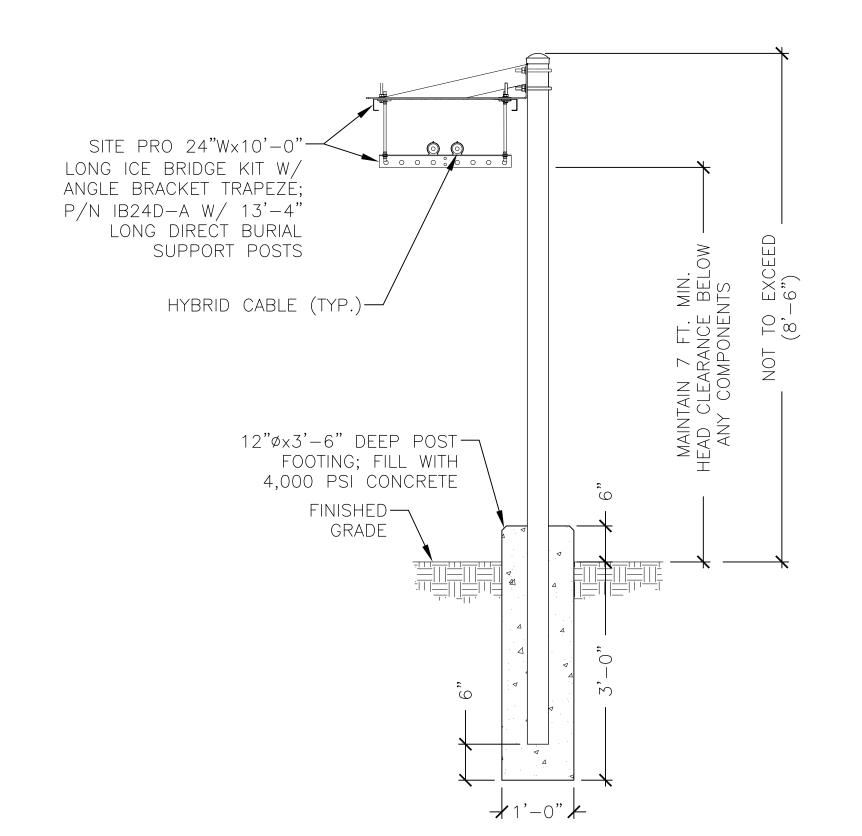


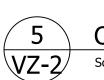


CABLE BRIDGE DETAIL Scale: N.T.S.

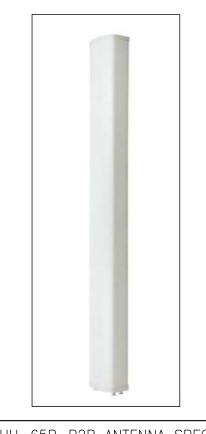

NHH-	65B-R2B	ANTENNA	SPEC.
HEIGHT	WIDTH	DEPTH	WEIGHT
72.0"	11.9"	7.1"	43.7 LBS

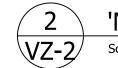

'NHH' ANTENNA SPEC. Scale: N.T.S.

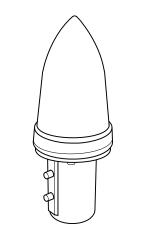

KS-24119	9L-112A	GPS ANTEN	INA SPEC
HEIGHT	WIDTH	DIAMETER	WEIGHT
5"	16.06"	3.17"	0.6 LBS


*ALL MOUNTING OPTIONS FIT PIPES OF 1"-1.45" MAX. DIA.





RVZDC	-6627-PI	F-48 'OVP	'SPECS.
HEIGHT	WIDTH	DEPTH	WEIGHT
29.5"	16.5"	12.6"	32 LBS



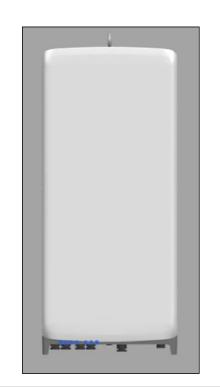






SAMSUNG F	RRH AWS/P	CS ORAN SF	PECIFICATION
HEIGHT	WIDTH	DIAMETER	WEIGHT
15"	15"	10"	74.7 LBS





NOTE: 1. "YELLOW" CAUTION SIGN SHALL BE LOCATED AT COMPOUND ENTRY LOCATION AND VERIZON EQUIPMENT. 2. SIGN MEASURES 12"Hx8"W



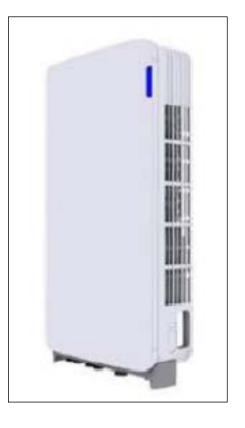

MT6413 ANTENNA/RRH SPECIFICATIONS			
HEIGHT	WIDTH	DEPTH	WEIGHT
28.9"	15.75"	5.5"	57.3 LBS





SAMSUNG F	RRH 700/8	50 ORAN SP	PECIFICATION
HEIGHT	WIDTH	DIAMETER	WEIGHT
15"	15"	9.1"	70.3 LBS




INFORMATION

This is an ACCESS POINT to an area with transmitting antennas.

Obey all postings and boundaries beyond this point. Call Verizon Wireless at 1-800-264-6620 for more information.

NOTE:

1. "GREEN" INFORMATION SIGN SHALL BE LOCATED AT COMPOUND ENTRY LOCATION AND VERIZON EQUIPMENT. 2. SIGN MEASURES 12"Wx8"H

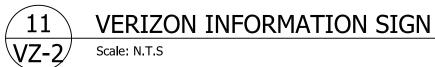






NEW YORK SMSA LIMITED PARTNERSHIP d/b/a VERIZON WIRELESS 4 CENTEROCK ROAD WEST NYACK, NY 10994



88 Foundry Pond Road Cold Spring, NY 10516 dweinpahl@onaireng.com 201-456-4624

UNAUTHORIZED ALTERATION OR ADDITION TO A DOCUMENT PREPARED BY A LICENSED ENGINEER IS A VIOLATION OF ARTICLE 145, SECTION 7209-2 OF THE NEW STATE EDUCATION LAW.

LICENSURE

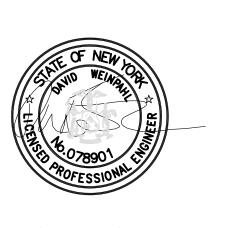

DAVID WEINPAHL, P.E. NY LIC NO. 078901

NO.:	DATE:	SUBMISSIONS
0	04.09.25	REVIEW SET
1	04.17.25	REVISED PER ATTORNEY COMMENTS
2	05.05.25	REVISED TO INCLUDE VERIZON
3	07.02.25	REVISED TOWER HEIGHT
4	10.10.25	REDUCED COMPOUND SIZE

DW AS

HOMELAND TOWERS SITE ID:

NY161 TALLMAN

VERIZON SITE NAME:

TALLMAN


PROJECT ADDRESS:

VILLAGE OF MONTEBELLO 350 HAVERSTRAW RD. MONTEBELLO, NY 10901

DRAWING TITLE:

VERIZON ANTENNA PLAN & DETAILS

SHEET NUMBER: VZ-2

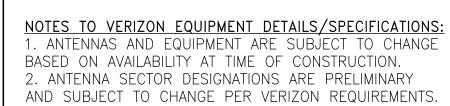

ADHESIVE FILM AND/OR PAINTING.